


DEMOLITION & RELOCATIONS LEGEND

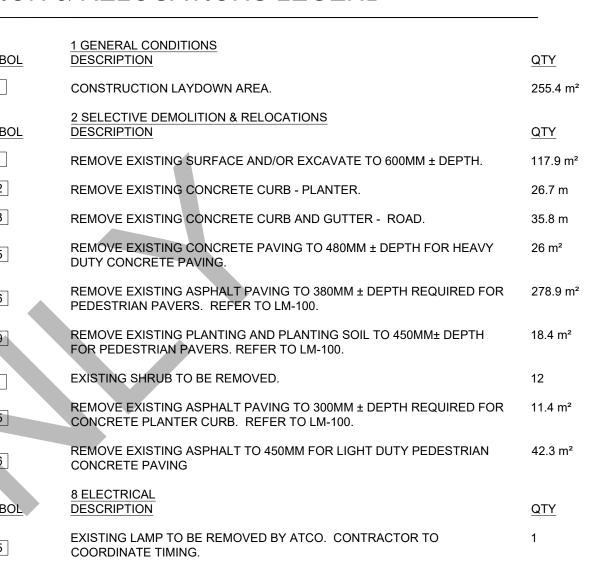



DRUMHELLER DOWNTOWN PLAZA

MUNICIPALITY OF DRUMHELLER

CONSULTANTS





EALS



ISSUED FOR: PCO #01 WASHROOM UTILITIES DATE: 2022-05-26

REVISIONS:		
NO. DESCRIPTION.	DATE.	B'
5 ISSUED FOR PCO #1	2022-05-26	
4 ISSUED FOR CONSTRUCTION	2022-05-06	
3 ISSUED LANDSCAPE ADDENDUM #3	2022-03-09	
2 ISSUED LANDSCAPE ADDENDUM #1	2022-02-18	

DESIGNED BY: ZW/MW PLOT DATE: 2022-05-03 DRAWING FILE NAME: LD-100 DEMO PLAN.dwg

1 ISSUED FOR TENDER


CHECKED BY: MW


2022-02-15

DEMO PLAN

LD-100

DRUMHELLER DOWNTOWN PLAZA 210201

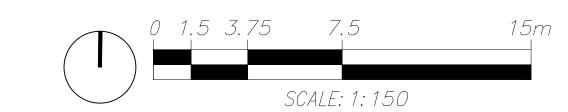

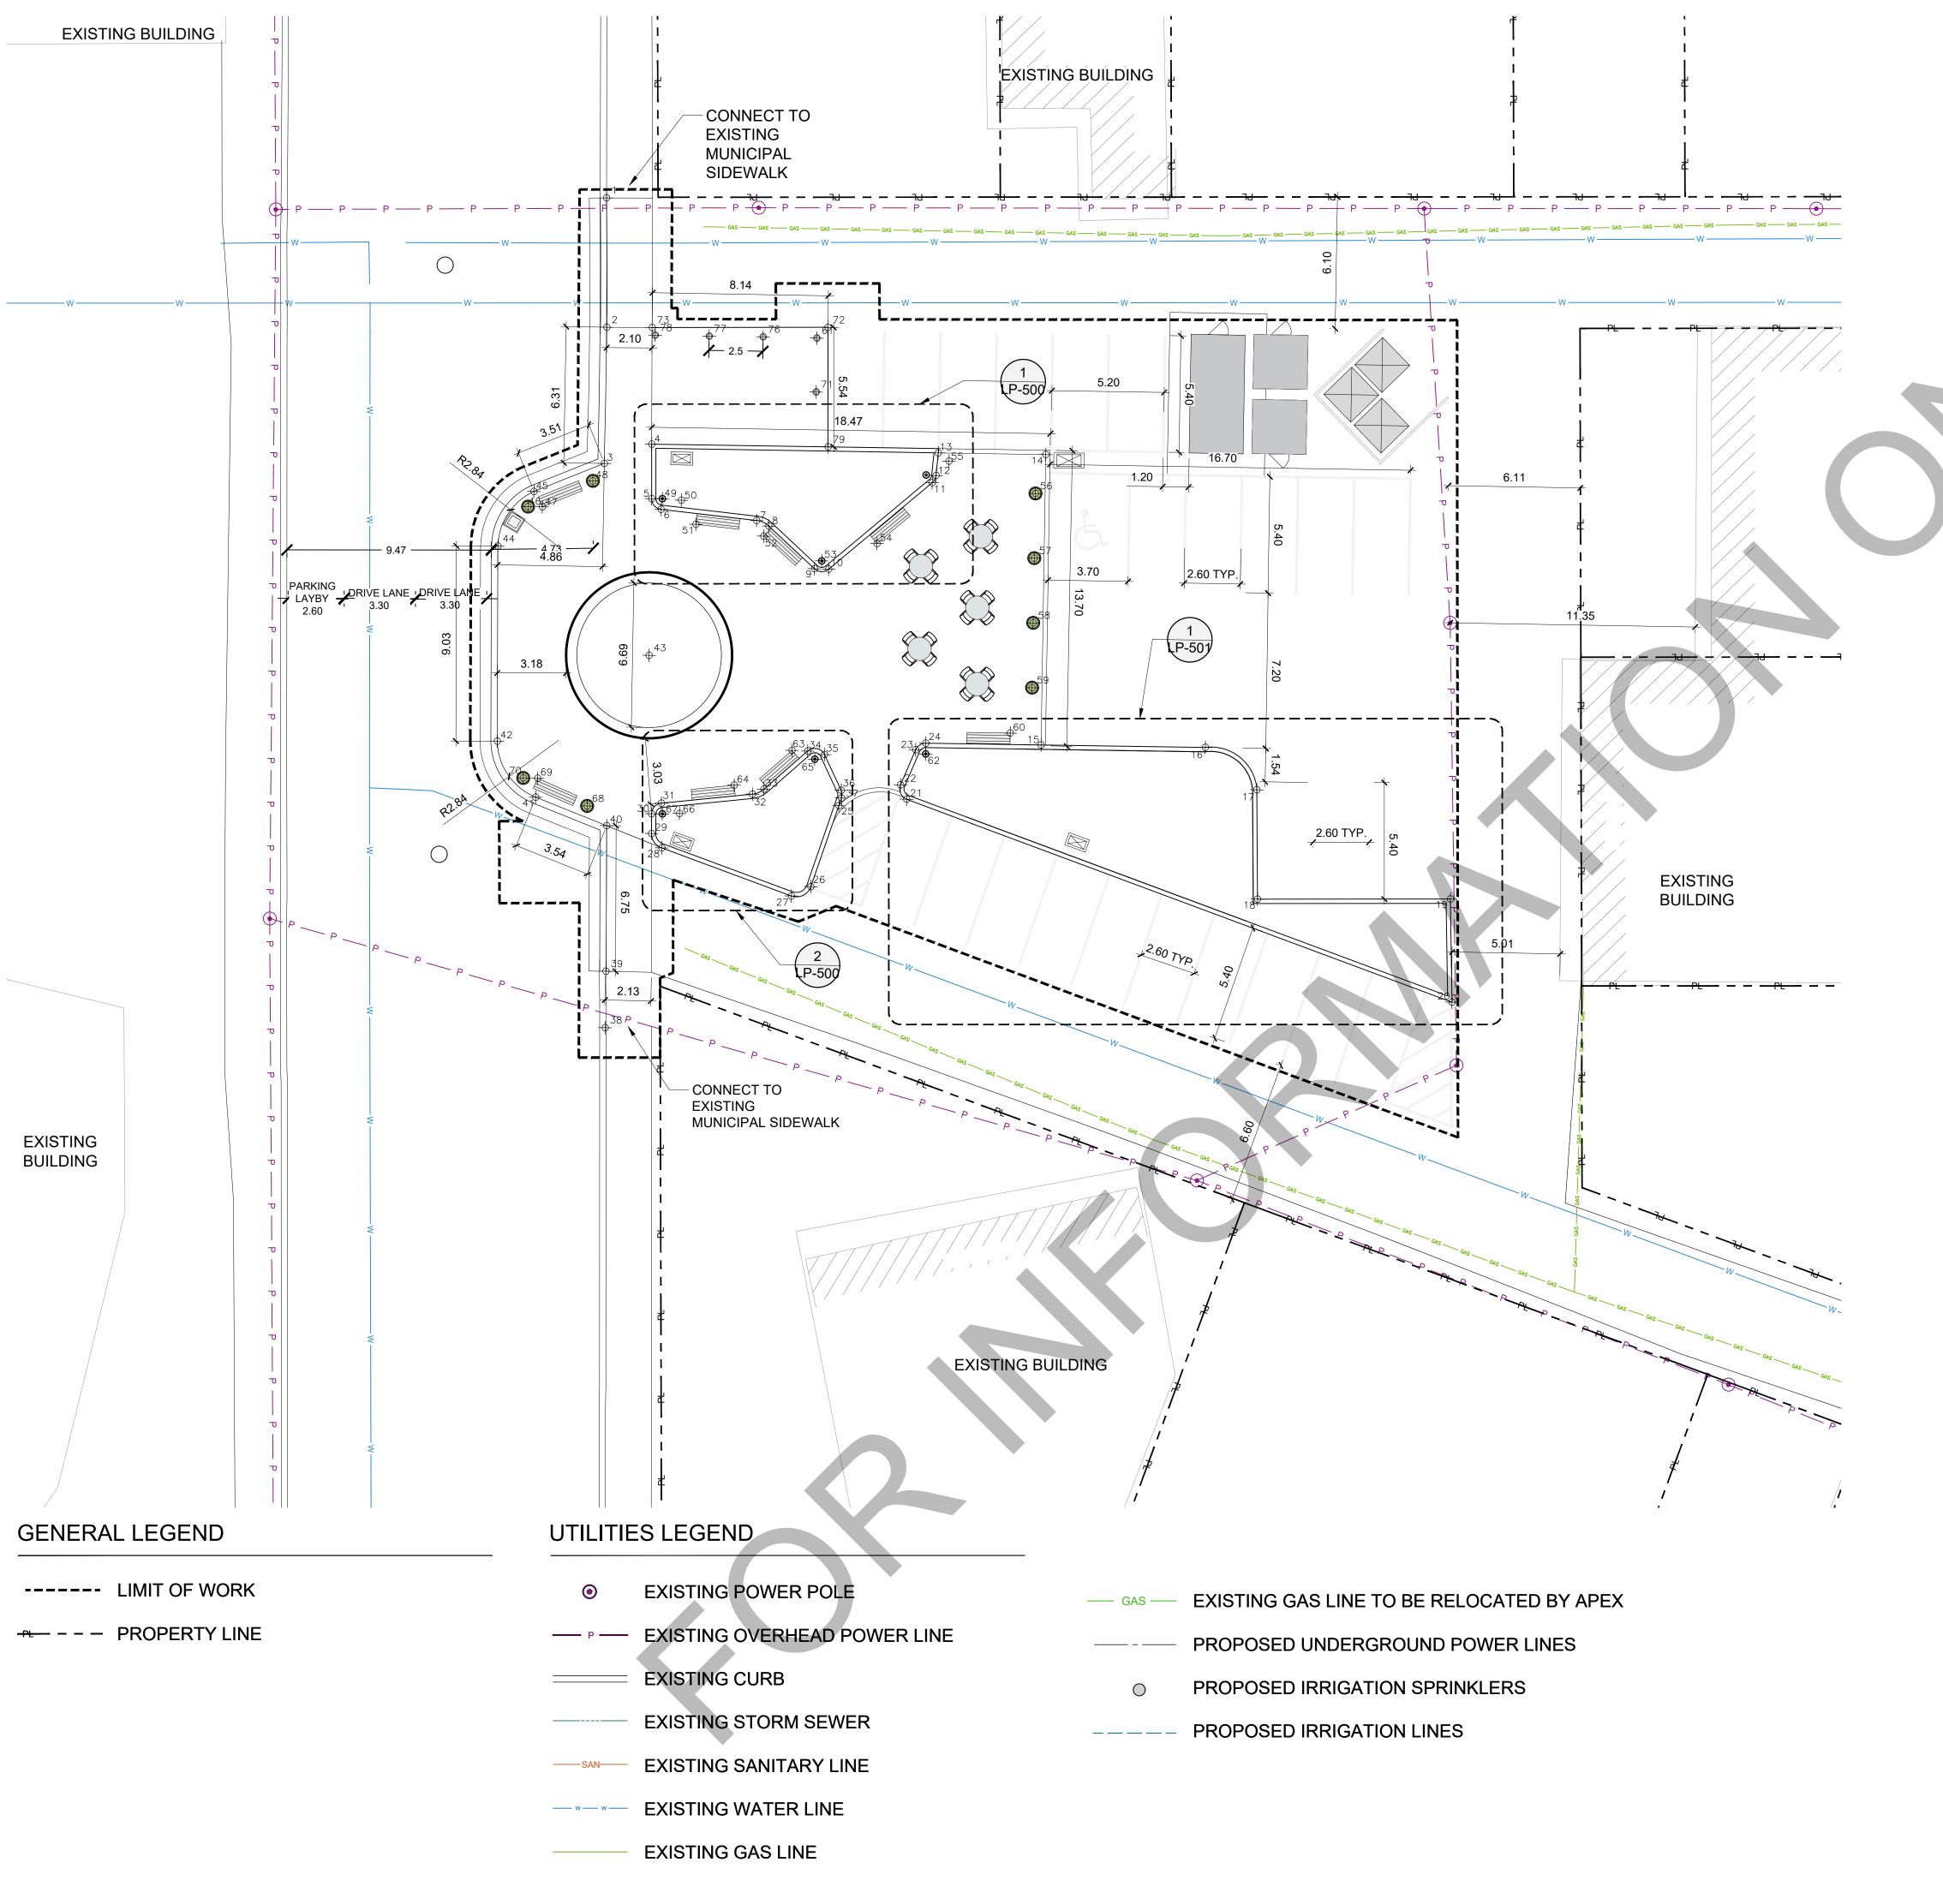

NORTHING AND EASTING POINTS

N 5703859.23	E 89700.15
N 5703853.24	E 89700.26
N 5703846.93	E 89700.26
N 5703847.86	E 89702.43
N 5703845.33	E 89702.47
N 5703844.84	E 89702.93
N 5703844.41	E 89707.36
N 5703844.15	E 89707.93
N 5703842.22	E 89710.07
N 5703842.21	E 89710.74
N 5703846.30	E 89715.46
N 5703846.63	E 89715.63
N 5703847.69	E 89715.72
N 5703847.69	E 89720.70
N 5703834.23	E 89720.72
N 5703834.25	E 89728.32
N 5703832.33	E 89730.74
N 5703827.27	E 89730.86
N 5703827.43	E 89739.80
N 5703822.65	E 89739.95
N 5703831.61	E 89714.53
N 5703832.27	E 89714.24
N 5703833.91	E 89714.91
N 5703834.22	E 89715.37
N 5703831.26	E 89711.40
N 5703827.48	E 89710.16
N 5703827.04	E 89709.27
N 5703829.16	E 89703.23
N 5703829.82	E 89702.74
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N 5703831.62	E 89711.51
N 5703820.78	E 89700.75
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N 5703845.57	E 89697.02
N 5703844.86	E 89696.76
N 5703844.87	E 89697.42
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DRUMHELLER DOWNTOWN PLAZA

MUNICIPALITY OF DRUMHELLER

CONSULTANTS





SEALS





ISSUED FOR: PCO #01 WASHROOM UTILITIES DATE: 2022-05-26


REVISIONS:		
NO. DESCRIPTION.	DATE.	В
5 ISSUED FOR PCO #1	2022-05-26	
4 ISSUED FOR CONSTRUCTION	2022-05-06	
3 ISSUED LANDSCAPE ADDENDUM	#3 2022-03-09	
2 ISSUED LANDSCAPE ADDENDUM	#1 2022-02-18	
1 ISSUED FOR TENDER	2022-02-15	
DESIGNED BY: ZW/MW CH	ECKED BY: MW	

DRAWING TITLE:
LAYOUT PLAN

LL-100

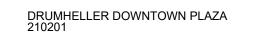

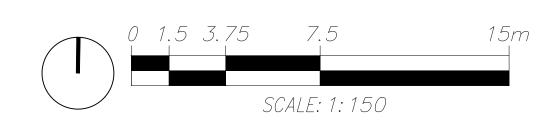

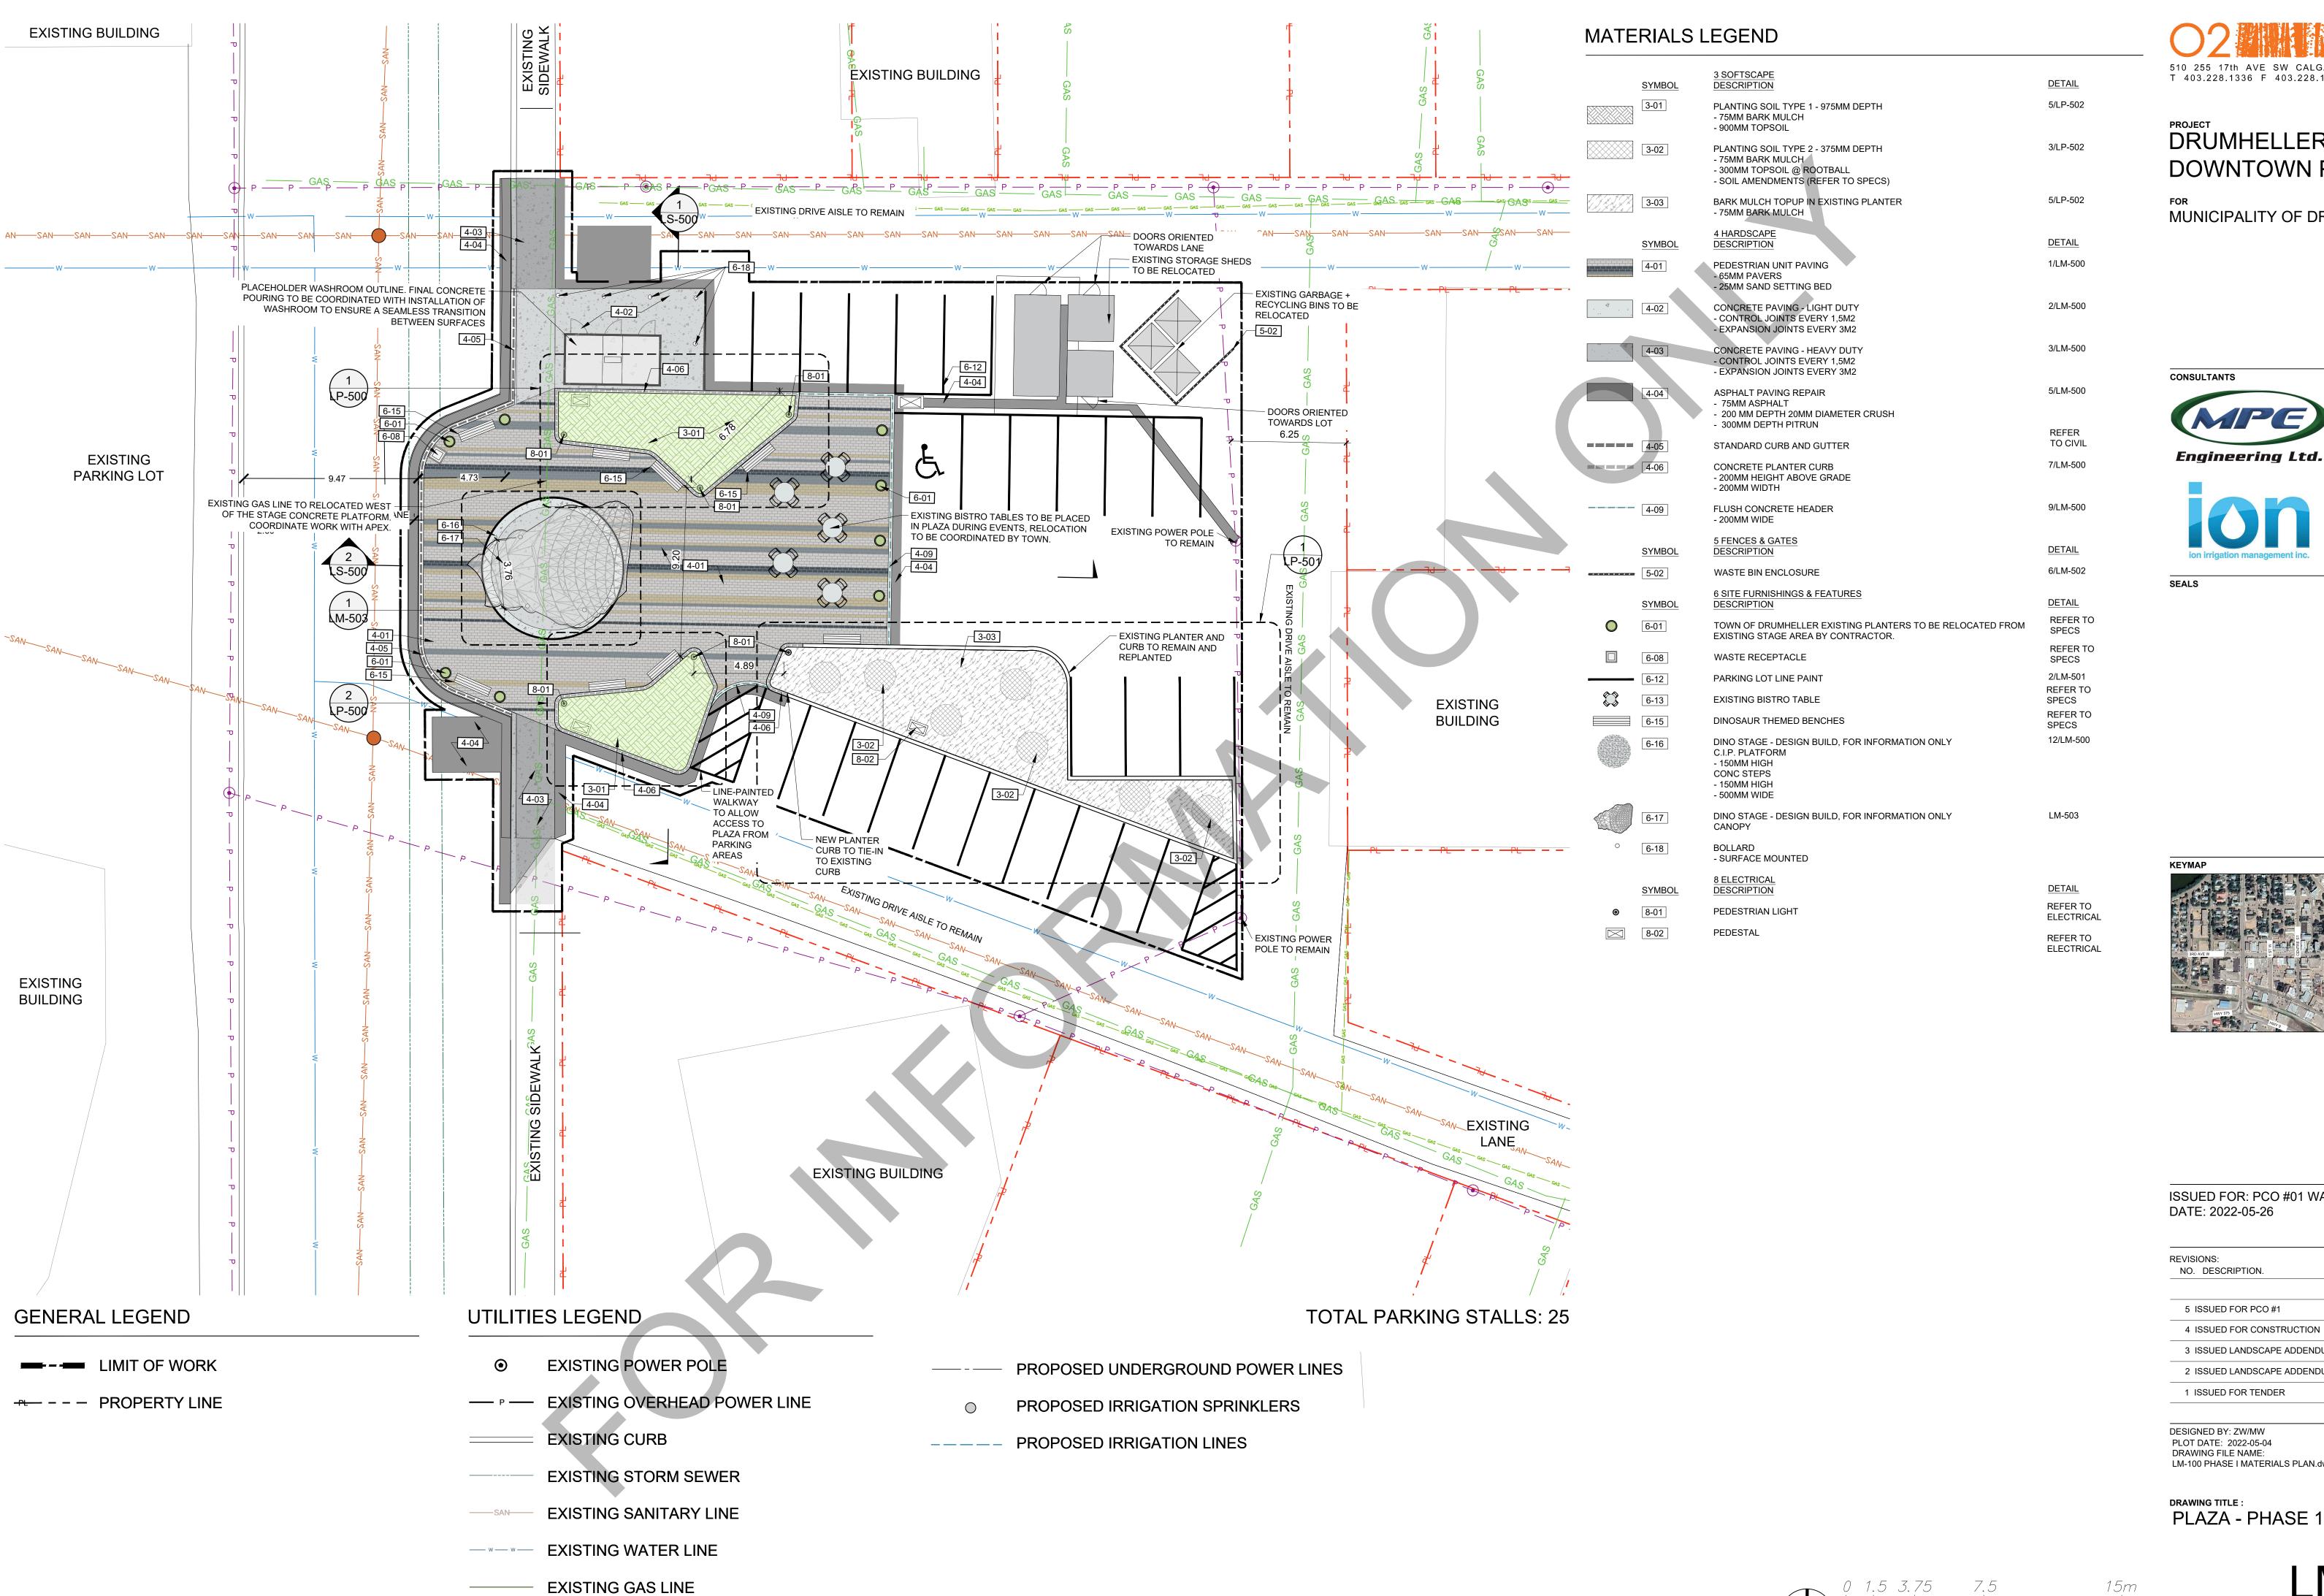

— GAS — EXISTING GAS LINE TO BE RELOCATED BY APEX



DRUMHELLER DOWNTOWN PLAZA

MUNICIPALITY OF DRUMHELLER







ISSUED FOR: PCO #01 WASHROOM UTILITIES DATE: 2022-05-26

NO. DESCRIPTION.	DATE.	Е
5 ISSUED FOR PCO #1	2022-05-26	
4 ISSUED FOR CONSTRUCTION	2022-05-06	
3 ISSUED LANDSCAPE ADDENDUM #3	2022-03-09	
2 ISSUED LANDSCAPE ADDENDUM #1	2022-02-18	
1 ISSUED FOR TENDER	2022-02-15	


DESIGNED BY: ZW/MW CHECKED BY: MW PLOT DATE: 2022-05-04 DRAWING FILE NAME: LM-100 PHASE I MATERIALS PLAN.dwg


DRAWING TITLE : PLAZA - PHASE 1

LM-101

DRUMHELLER DOWNTOWN PLAZA 210201

SCALE: 1: 150

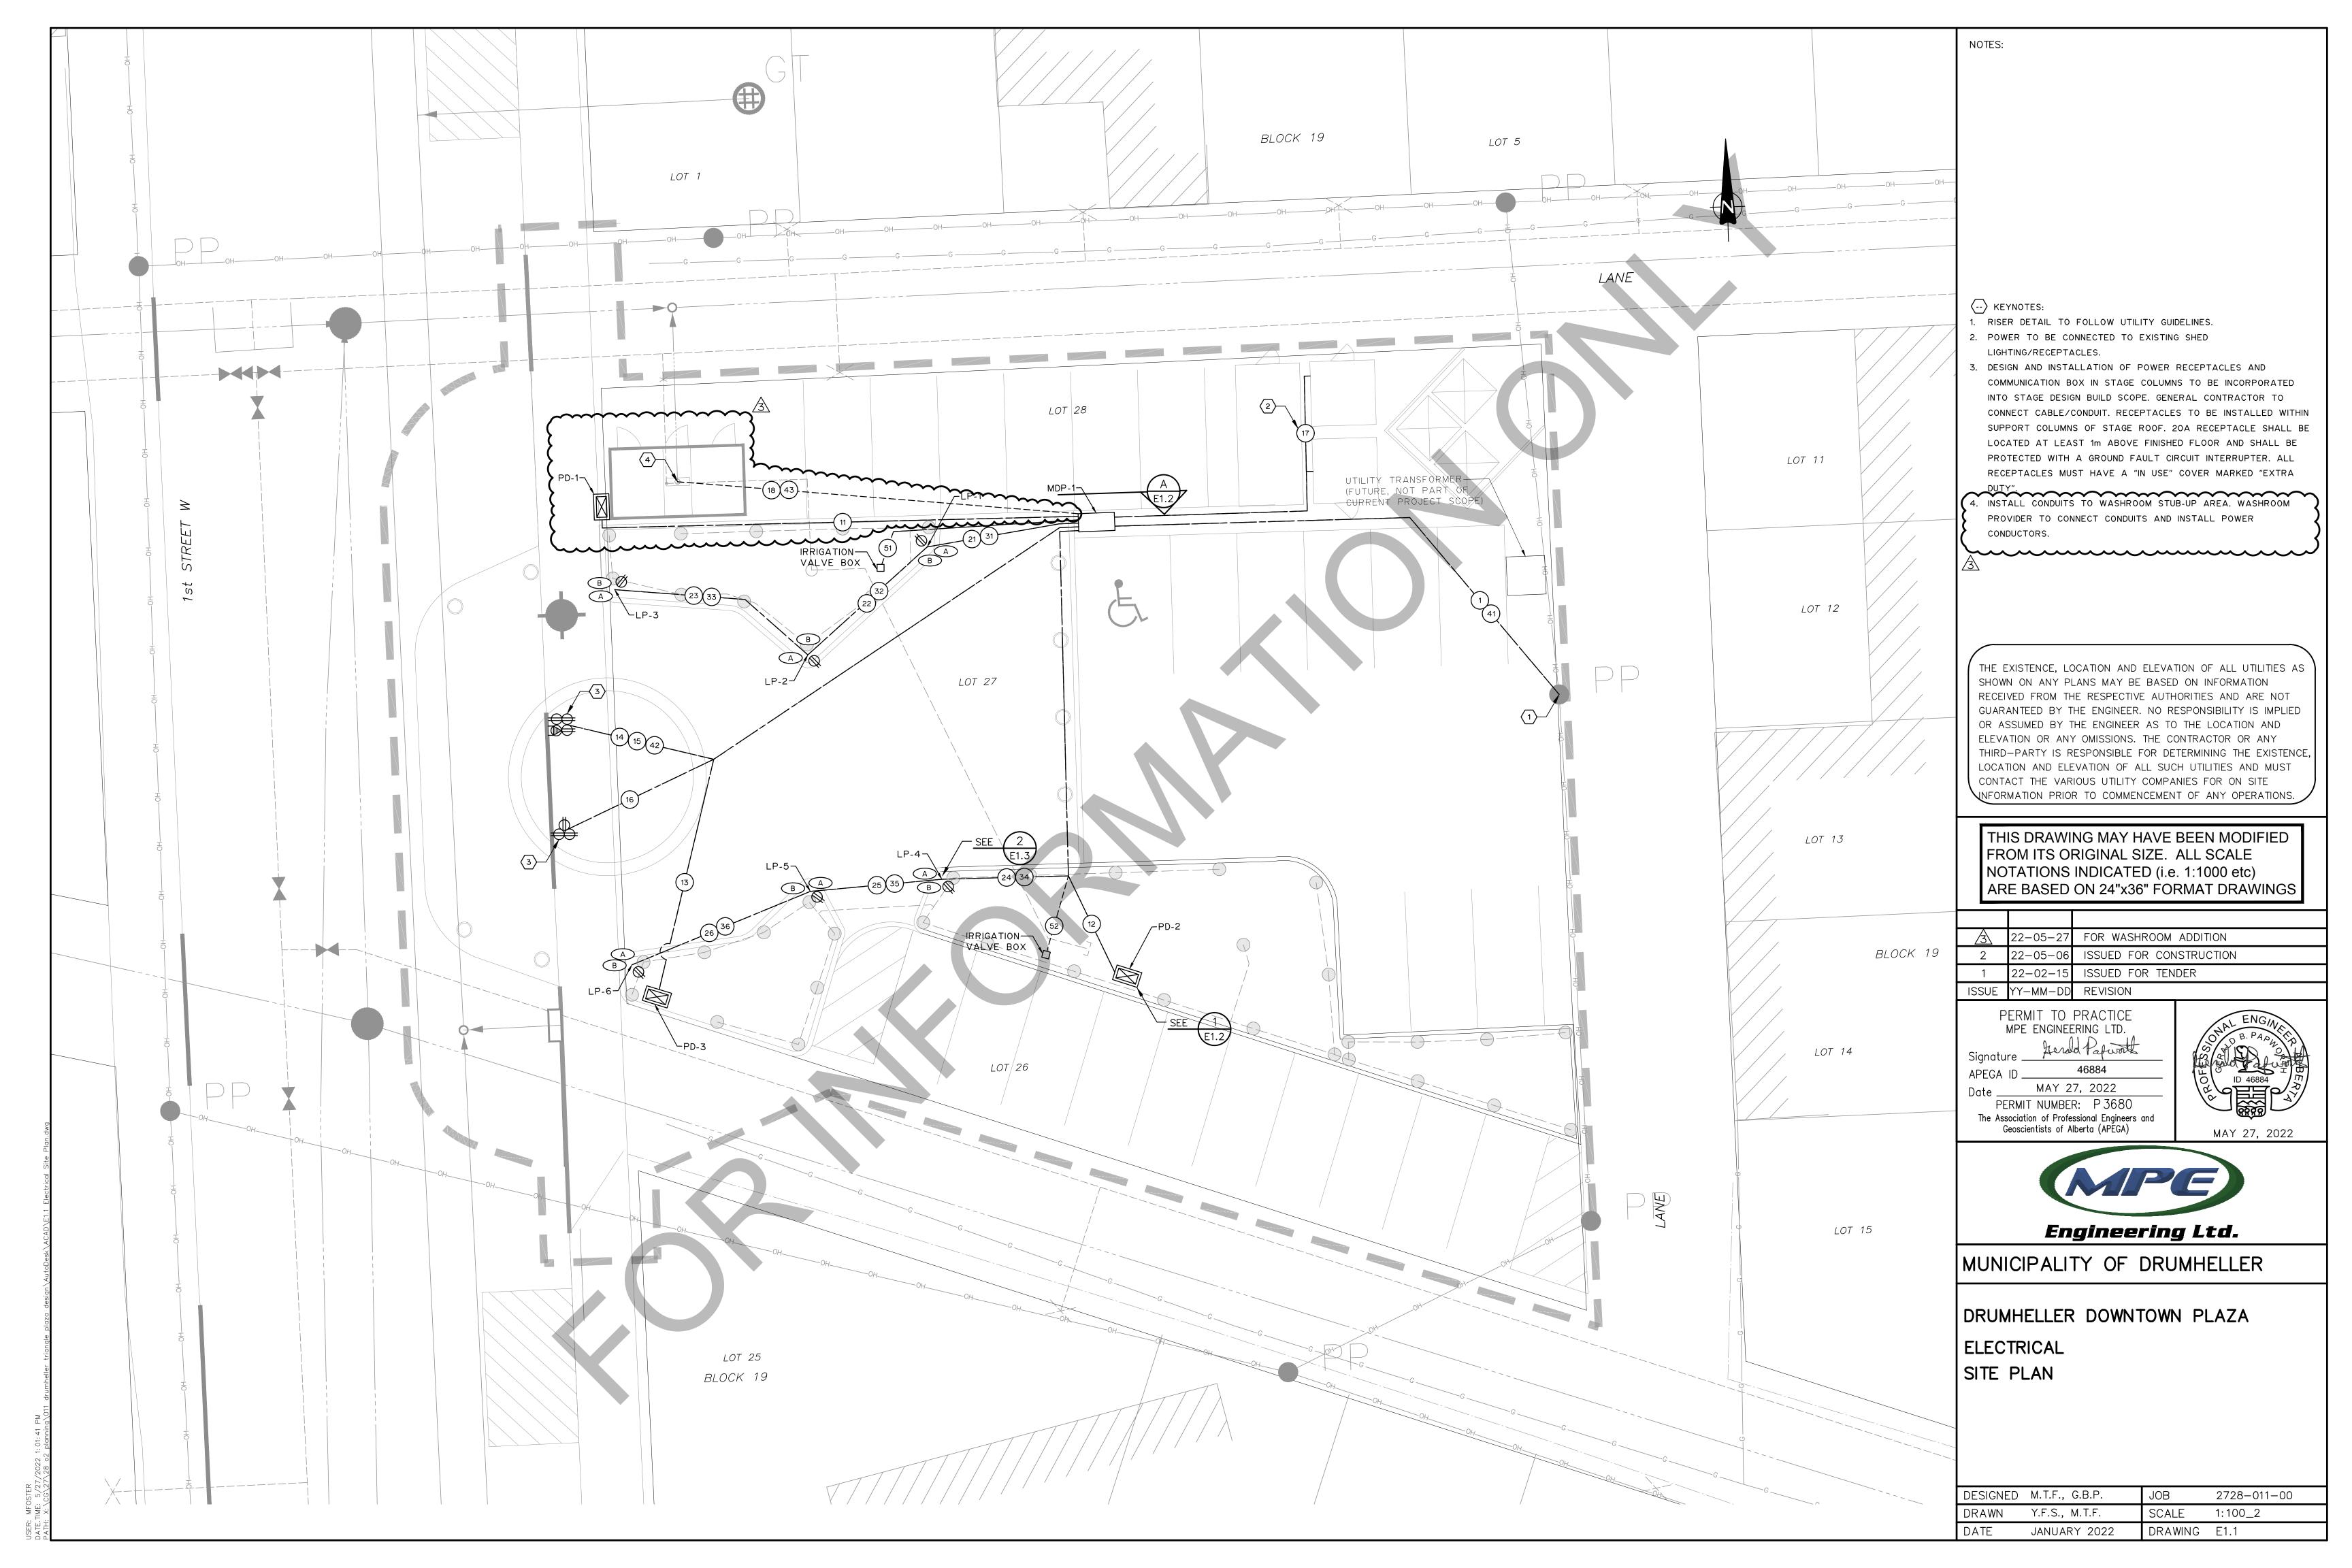

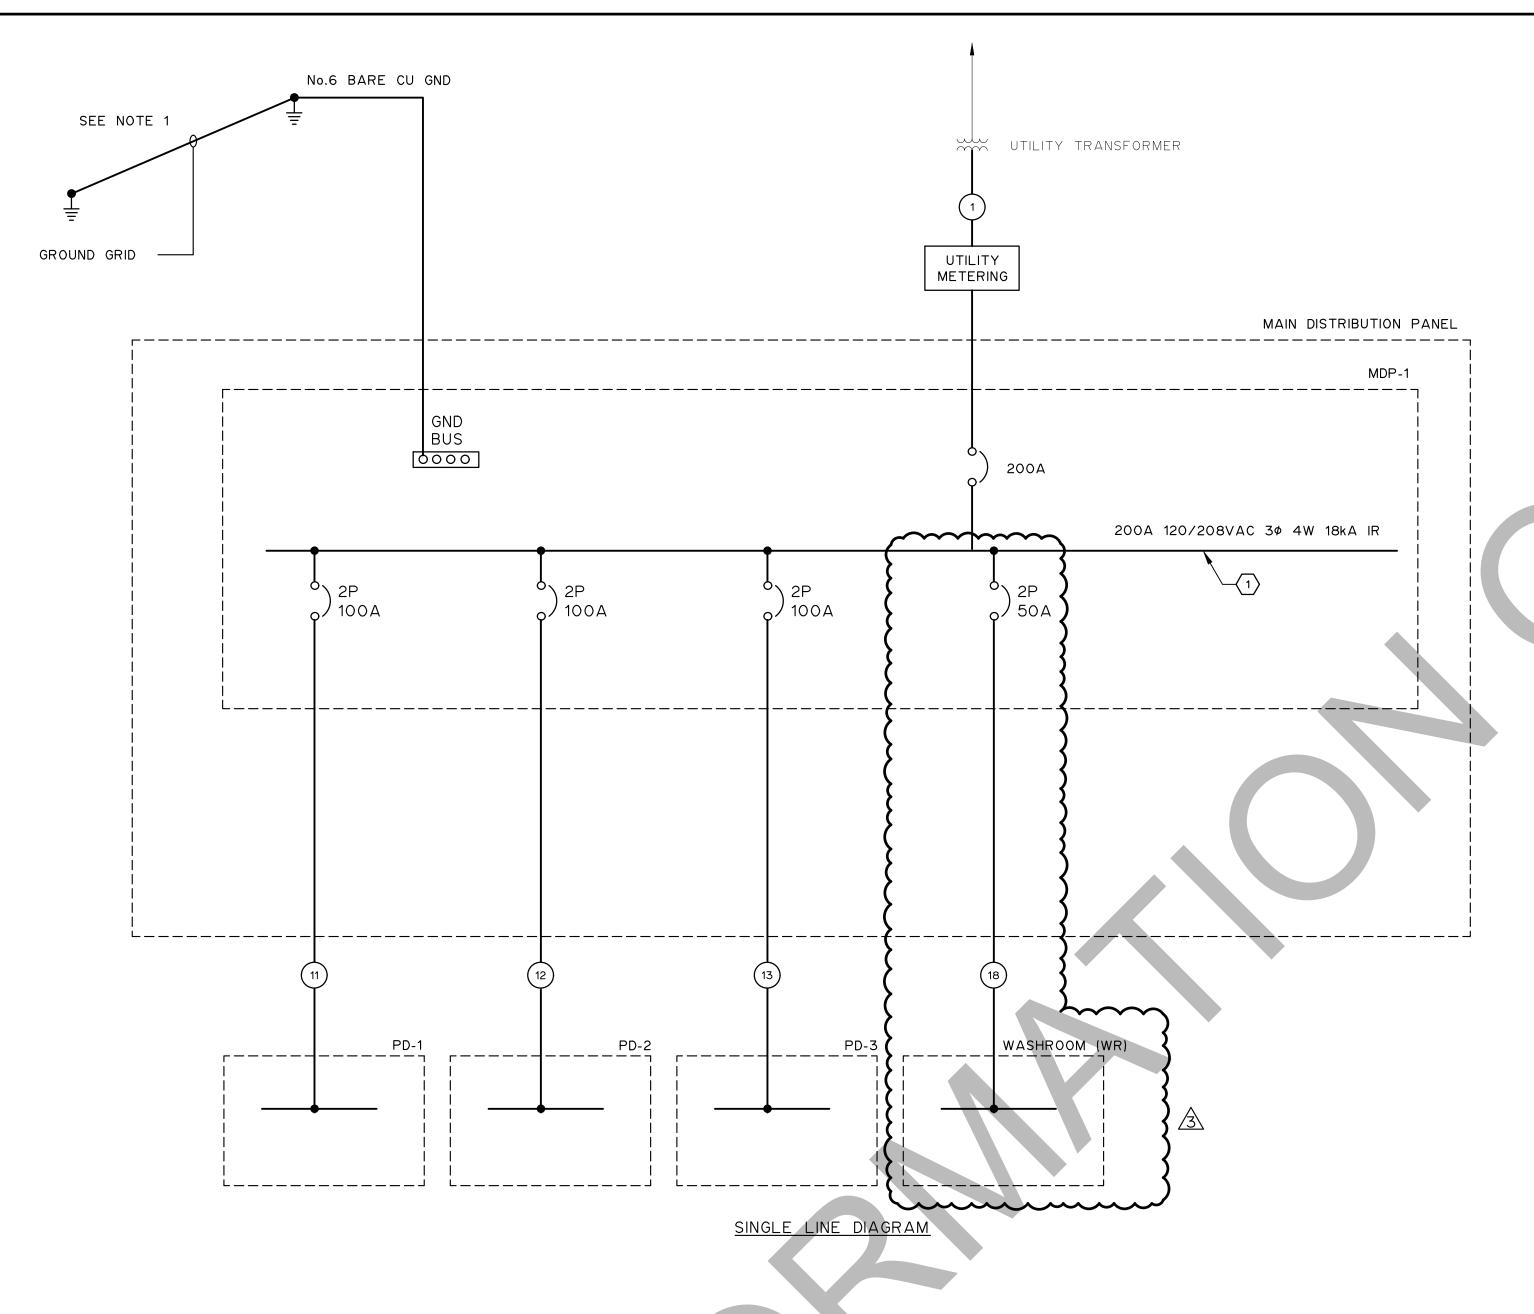

				ANEL: MDF				
		LOC	ATION:	DRUMHEL	LER PL	.AZA		
		120/208V 3PH 4W 200A						
DESCRIPTION	LOAD (KW)	TRIP AMPS	BRK. NO.	PHASE	BRK. NO.	TRIP AMPS	LOAD (KW)	DESCRIPTION
STAGE (50A)	8.3	50	1	А	2	100	16.6	PD-1
	6.3	30	3	В	4	100	100 16.6	
50A RECEPTACLE LOCAL	0.7	F.0	5	С	6	10.0	16.6	PD-2
	8.3	50	7	А	8	100	16.6	
30A RECEPTACLE LOCAL	2.9	30	9	В	10	100	10.0	PD-3
20A RECEPTACLE LOCAL	1.9	20	11	С	12	100	16.6	
STAGE NORTH (20A)	1.9	20	13	А	14	20	1.9	STAGE SOUTH (20A)
STAGE NORTH (20A)	1.9	20	15	В	16	20	1.9	STAGE SOUTH (20A)
STAGE NORTH (20A)	1.9	20	17	С	18	20	1.9	STAGE SOUTH (20A)
IRRIGATION CONTROL PANEL	1.9	20	19	А	20	20	1.9	LIGHT POLE RECEPTACLE NORTH
LIGHTING CONTROL PANEL	1.9	20	21	В	22	20	1.9	LIGHT POLE RECEPTACLE SOUTH
LIGHTS	1.9	20	23	С	24	20	1.9	MDP-1 INTERIOR LIGHTS
MDP-1 INTERIOR RECEPTACLE (POWER)	1.4	15	25	А	26	15	1.4	MDP-1 INTERIOR RECEPTACLE (CONTROL)
HEATER	0.4	15	27	В	28	15		SPARE
SPARE		15	29	С	30	15~	~~	SPARE
			31	А	32			WASHROOM PANEL
			33	В	34	50	5.0	
			35	С	36	<u> </u>	~~	
			37	А	38			
			39	В	40			
			41	С	42			

MDP-1 PANEL SCHEDULE

				ANEL DO	. 4			
		PANEL: PD-1 LOCATION:						
				8V 1PH 3				
DESCRIPTION	LOAD (W)	TRIP AMPS	BRK. NO.	PHASE	BRK. NO.	TRIP AMPS	LOAD (W)	DESCRIPTION
50A RECEPTACLE		50	1	А	5	30		20A RECEPTACLE
		30	2	В	6	20		SPARE
30A RECEPTACLE		30	3	А	7			SPARE
20A RECEPTACLE		20	4	В	8			SPARE

			P	ANEL: PD	-2			
			l	_OCATION	:			
			120/208	3V 1PH 3	W 100A	١		
DESCRIPTION	LOAD (W)	TRIP AMPS	BRK. NO.	PHASE	BRK. NO.	TRIP AMPS	LOAD (W)	DESCRIPTION
50A RECEPTACLE		50	1	С	5	30		20A RECEPTACLE
		50	2	А	6	20		SPARE
30A RECEPTACLE		30	3	С	7			SPARE
20A RECEPTACLE		20	4	А	8			SPARE

			Р	ANEL: PD	-3			
				LOCATION	:			
			120/20	8V 1PH 3	W 100A			
DESCRIPTION	LOAD (W)	TRIP AMPS	BRK. NO.	PHASE	BRK. NO.	TRIP AMPS	LOAD (W)	DESCRIPTION
OA RECEPTACLE		50	1	В	5	30		20A RECEPTACLE
		30	2	С	6	20		SPARE
OA RECEPTACLE		30	3	В	7			SPARE
OA RECEPTACLE	RECEPTACLE 20 4 C 8							SPARE

NOTES

- 1. NEW GROUND GRID AS FOLLOWS:
- THERE MUST BE TWO MANUFACTURED ROD ELECTRODES C/W GROUND WELL AND CLAMP.
- EACH ROD SHALL BE MINIMUM 19mm DIAMETER AND 3m LENGTH.
- THE RODS MUST BE SPACED 3m APART.
- THE RODS MUST BE BONDED TOGETHER BY BARE No.6 GROUNDING CONDUCTOR.
- GROUND WELL TO BE ACE MANUFACTURING MODEL AGW.

--> KEYNOTES:

1. ONLY SUB PANELS SHOWN ON SINGLE LINE. SEE MDP-1 PANEL SCHEDULE FOR ALL LOADS.


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<u> 3</u>	22-05-27	FOR WASHROOM ADDITION
2	22-05-06	ISSUED FOR CONSTRUCTION
1	22-02-15	ISSUED FOR TENDER
ISSUE	YY-MM-DD	REVISION

PERMIT TO PRACTICE MPE ENGINEERING LTD.

Signature _____

Date MAY 27, 2022
PERMIT NUMBER: P 3680
The Association of Professional Engineers and Geoscientists of Alberta (APEGA)



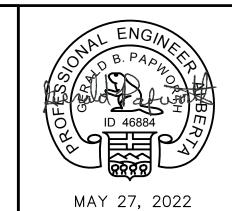

MUNICIPALITY OF DRUMHELLER

DRUMHELLER DOWNTOWN PLAZA
ELECTRICAL
SINGLE LINE DIAGRAM

DESIGNED	M.T.F., G.B.P.	JOB	2728-011-00
DRAWN	Y.F.S., M.T.F.	SCALE	NTS
DATE	JANUARY 2022	DRAWING	E2.1

				LUMINA	IRE SCHEDULE						
TAG	DESCRIPTION	MANUFACTURER/MODEL (OR APPROVED EQUIVALENT)	MOUNTING HEIGHT	LAMP	LENS	FIXTURE LUMEN OUTPUT	COLOUR TEMPERATURE	MOUNTING	VOLT	LIFESPAN	REMARKS
А	POLE MOUNTED FIXTURE	LUMINIS SC655L1L15R55120VGRTK3HLPCST	12',14',16'	LED	HEXCELL LOUVER	1599	3000K	POLE MOUNT	120	60,000 HRS	3 LIGHTS MOUNTED AT DIFFERENT HEIGHTS ON EACH POLE
В	LIGHT POLE 18'	LUMINIS PAA518-1 GRT CGF									18' POLE

					CABLE S	CHEDIII E				
	0.00.5.7.0	5001				GIEDOLL	00101117 (0.40) 5	V0. 7405		A NOTES
REF	CABLE TAG	FROM	ТО		CONDUCTOR DETAILS		CONDUIT/CABLE	VOLTAGE	LENGTH	NOTES
		EQUIP TAG	EQUIP TAG	NO. OF COND	SIZE AWG	TYPE			(METERS)	
1	MDP-1	UTILITY	MDP-1	4	250	ACWU90		208VAC	TBD	UTILITY
11	PD-1	MDP-1	PD-1	3	1/0	ACWU90		208VAC	TBD	PEDESTAL 1
12	PD-2	MDP-1	PD-2	3	1/0	ACWU90		208VAC	TBD	PEDESTAL 2
13	PD-3	MDP-1	PD-3	3	1/0	ACWU90		208VAC	TBD	PEDESTAL 3
14	STG-N2	MDP-1	STG-N	3	8	TECK90		208VAC	TBD	STAGE NORTH 50A RECEPTACLE
15	STG-N1	MDP-1	STG-N	6	10	TECK90		120VAC	TBD	STAGE NORTH 20A RECEPTACLES
16	STG-S1	MDP-1	STG-S	6	10	TECK90		120VAC	TBD	STAGE NORTH 20A RECEPTACLES
17	SHD	MDP-1	SHD	4	12	TECK90		120VAC	TBD	SHED POWER
18	WR	MDP-1	WR	3 + GND	8	R90	C18	208VAC	TBD	WASHROOM PANEL
21	LP-1P	MDP-1	LP-1	4	12	TECK90		120VAC	TBD	LIGHT POLE 1 LIGHTS/RECEPTACLE
22	LP-2P	LP-1	LP-2	4	12	TECK90		120VAC	TBD	LIGHT POLE 2 LIGHTS/RECEPTACLE
23	LP-3P	LP-2	LP-3	4	12	TECK90		120VAC	ТВО	LIGHT POLE 3 LIGHTS/RECEPTACLE
24	LP-4P	MDP-1	LP-4	4	12	TECK90		120VAC	TBD	LIGHT POLE 4 LIGHTS/RECEPTACLE
25	LP-5P	LP-4	LP-5	4	12	TECK90		120VAC	TBD	LIGHT POLE 5 LIGHTS/RECEPTACLE
26	LP-6P	LP-5	LP-6	4	12	TECK90		120VAC	TBD	LIGHT POLE 6 LIGHTS/RECEPTACLE
31	LP-1C	MDP-1	LP-1	1PR	18	SHLD	C31	10VDC	TBD	LIGHT POLE 1 LIGHT CONTROL
32	LP-2C	LP-1	LP-2	1PR	18	SHLD	C32	10VDC	TBD	LIGHT POLE 2 LIGHT CONTROL
33	LP-3C	LP-2	LP-3	1PR	18	SHLD	C33	10VDC	TBD	LIGHT POLE 3 LIGHT CONTROL
34	LP-4C	MDP-1	LP-4	1PR	18	SHLD	C34	10VDC	TBD	LIGHT POLE 4 LIGHT CONTROL
35	LP-5C	LP-4	LP-5	1PR	18	SHLD	C35	10VDC	TBD	LIGHT POLE 5 LIGHT CONTROL
36	LP-6C	LP-5	LP-6	1PR	18	SHLD	C36	10VDC	TBD	LIGHT POLE 6 LIGHT CONTROL

						CONDUIT SCHEDULE				
	REF	CONDUIT TAG	FROM	ТО		CONDUIT DETAILS		VOLTAGE	LENGTH	NOTES
			EQUIP TAG	EQUIP TAG	QTY	SIZE	TYPE		(METERS)	
7	18	C-18	MDP-1	WR	1	35	RPVC	208VAC	TBD	WASHROOM DISTRIBUTION PANEL
	31	C31	MDP-1	LP-1	1	21	HDPE	24VDC	TBD	CONTROL/NETWORK
	32	C32	LP-1	LP-2	1	21	HDPE	24VDC	TBD	CONTROL/NETWORK
	33	C33	LP-2	LP-3	1	21	HDPE	24VDC	TBD	CONTROL/NETWORK
	34	C34	MDP-1	LP-4	1	21	HDPE	24VDC	TBD	CONTROL/NETWORK
	35	C35	LP-4	LP-5	1	21	HDPE	24VDC	TBD	CONTROL/NETWORK
	36	C36	LP-5	LP-6	1	21	HDPE	24VDC	TBD	CONTROL/NETWORK
	41	C41	ISP	MDP-1	1	35	HDPE	24VDC	TBD	INTERNET PROVIDER
	42	C42	MDP-1	STG-N	1	21	HDPE	24VDC	TBD	NETWORK STAGE
	43	C43	MDP-1	WR	1	21	HDPE	24VDC	TBD	WASHROOM CONTROL NETWORK
	51	C51	MDP-1	VLV-N	1	35	HDPE	24VDC	TBD	IRRIGATION VALVE BOX NORTH
	52	C52	MDP-1	VLV-S	1	35	HDPE	24VDC	TBD	IRRIGATION VALVE BOX SOUTH

		EQUIPMENT S	CHEDULE		
ITEM	QUANTITY	DESCRIPTION	MAKE	MODEL	NOTES
E1	1	KIOSK	VALID	DSKA664628-220155	INCLUDE INSULATION AND LIGHTING
E2	1	KIOSK PRECAST CONCRETE BASE	WESTCON	W2-05	
E3	1	DISTRIBUTION PANEL 42 CIRCUIT	EATON	PRL1a	
E4	3	PEDESTAL C/W 50A, 30A, 2X20A	VALID	CPB-PM-MB-HB	
E5	1	LIGHTING RELAY PANEL	ACUITY BRANDS nLIGHT	8SPR	
E6	1	SURGE PROTECTION DEVICE	SURGE PURE	M2-1208-4	
E7	1	ETHERNET SWITCH 5 PORT			
E8	1	HEATER 400W	HAMMOND	FLHTF400A115	
E9	6	LIGHT POLE BASE	WESTCON	W4-07 (1)	9" BOLT CIRCLE DIAMETER

NOTES:

- 1. THE CONDUIT AND CABLE SCHEDULE IS INTENDED TO SHOW THE MAJORITY OF THE POWER AND INSTRUMENTATION CABLE RUNS. INSTALL AND CONNECT ALL CABLES AND CONDUIT TO PROVIDE A COMPLETE AND OPERATIONAL SYSTEM.
- 2. SEE ELECTRICAL PANEL AND MECHANICAL EQUIPMENT SCHEDULES FOR ADDITIONAL WIRING REQUIREMENTS.
- 3. LIKE VOLTAGE WIRING CAN BE COMBINED IN COMMON CONDUIT PROVIDING MINIMUM 25% SPARE IN ACCOUNTED FOR IN ADD IN TO CEC CONDUIT FILL REQUIREMENTS. SEPARATE CONDUITS ARE REQUIRED FOR 120VAC, 24VDC, ANALOG SIGNALS, COMMUNICATION.
- 4. ALL IN CONCRETE SLAB RIGID ALUMINUM (ALUM) CONDUIT TO HAVE OUTSIDE OF CONDUIT COVERED WITH CORROSION PROTECTIVE COATING BITUMASTIC, ASPHALT BASED PAINT OR PVC COATING.
- 5. IN CONCRETE SLAB CONDUITS TO BE RPVC OR RIGID
- ALUMINUM.
- 6. IN CEILING CONDUITS TO BE EMT.
- 7. SURFACE MOUNT CONDUITS TO BE RPVC AND ARE ONLY PERMITTED FOR VERTICAL RUNS INTO CEILING SPACE AND HORIZONTAL RUNS LESS THAN 600. INSTALL ALL CONDUITS IN WALLS, CEILINGS AND FLOORS UNLESS OTHERWISE INDICATED.
- 8. ALL CABLING SIZE BASED ON 75° TERMINATION
- TEMPERATURE.
- 9. PROVIDE AND INSTALL APPROPRIATELY SIZED GROUND CABLE FOR ALL CABLE RUNS.
- 10. ALL CABLES ARE TO BE COPPER UNLESS OTHERWISE NOTED.
- 11. GROUND WIRE NOT SHOWN.

⟨--⟩ KEYNOTES:

 ALTERNATE MAKE/MODELS INCLUDE: MAKE: LAFARGE, MODEL: 9203 MAKE: PROFORM, MODEL: LP2134

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ISSUE	YY-MM-DD	REVISION

PERMIT TO PRACTICE MPE ENGINEERING LTD.

Signature ___ APEGA ID ___

MAY 27, 2022



MUNICIPALITY OF DRUMHELLER

DRUMHELLER DOWNTOWN PLAZA
ELECTRICAL
SCHEDULES

DESIGNED	M.T.F., G.B.P.	JOB	2728-011-00
DRAWN	Y.F.S., M.T.F.	SCALE	NTS
DATE	JANUARY 2022	DRAWING	F24

