
TOWN OF DRUMHELLER

PACKAGE C DIKE PROJECT NORTH DRUMHELLER DIKE C LANDSCAPE PLANTING TENDER PACKAGE


DRAWING LIST

Sheet Number	Sheet Title
L-100	LANDSCAPE PLANTING COVER SHEET & KEY PLAI
L-401	PLANTING PLAN
L-402	PLANTING PLAN
L-403	PLANTING PLAN
L-404	PLANTING PLAN




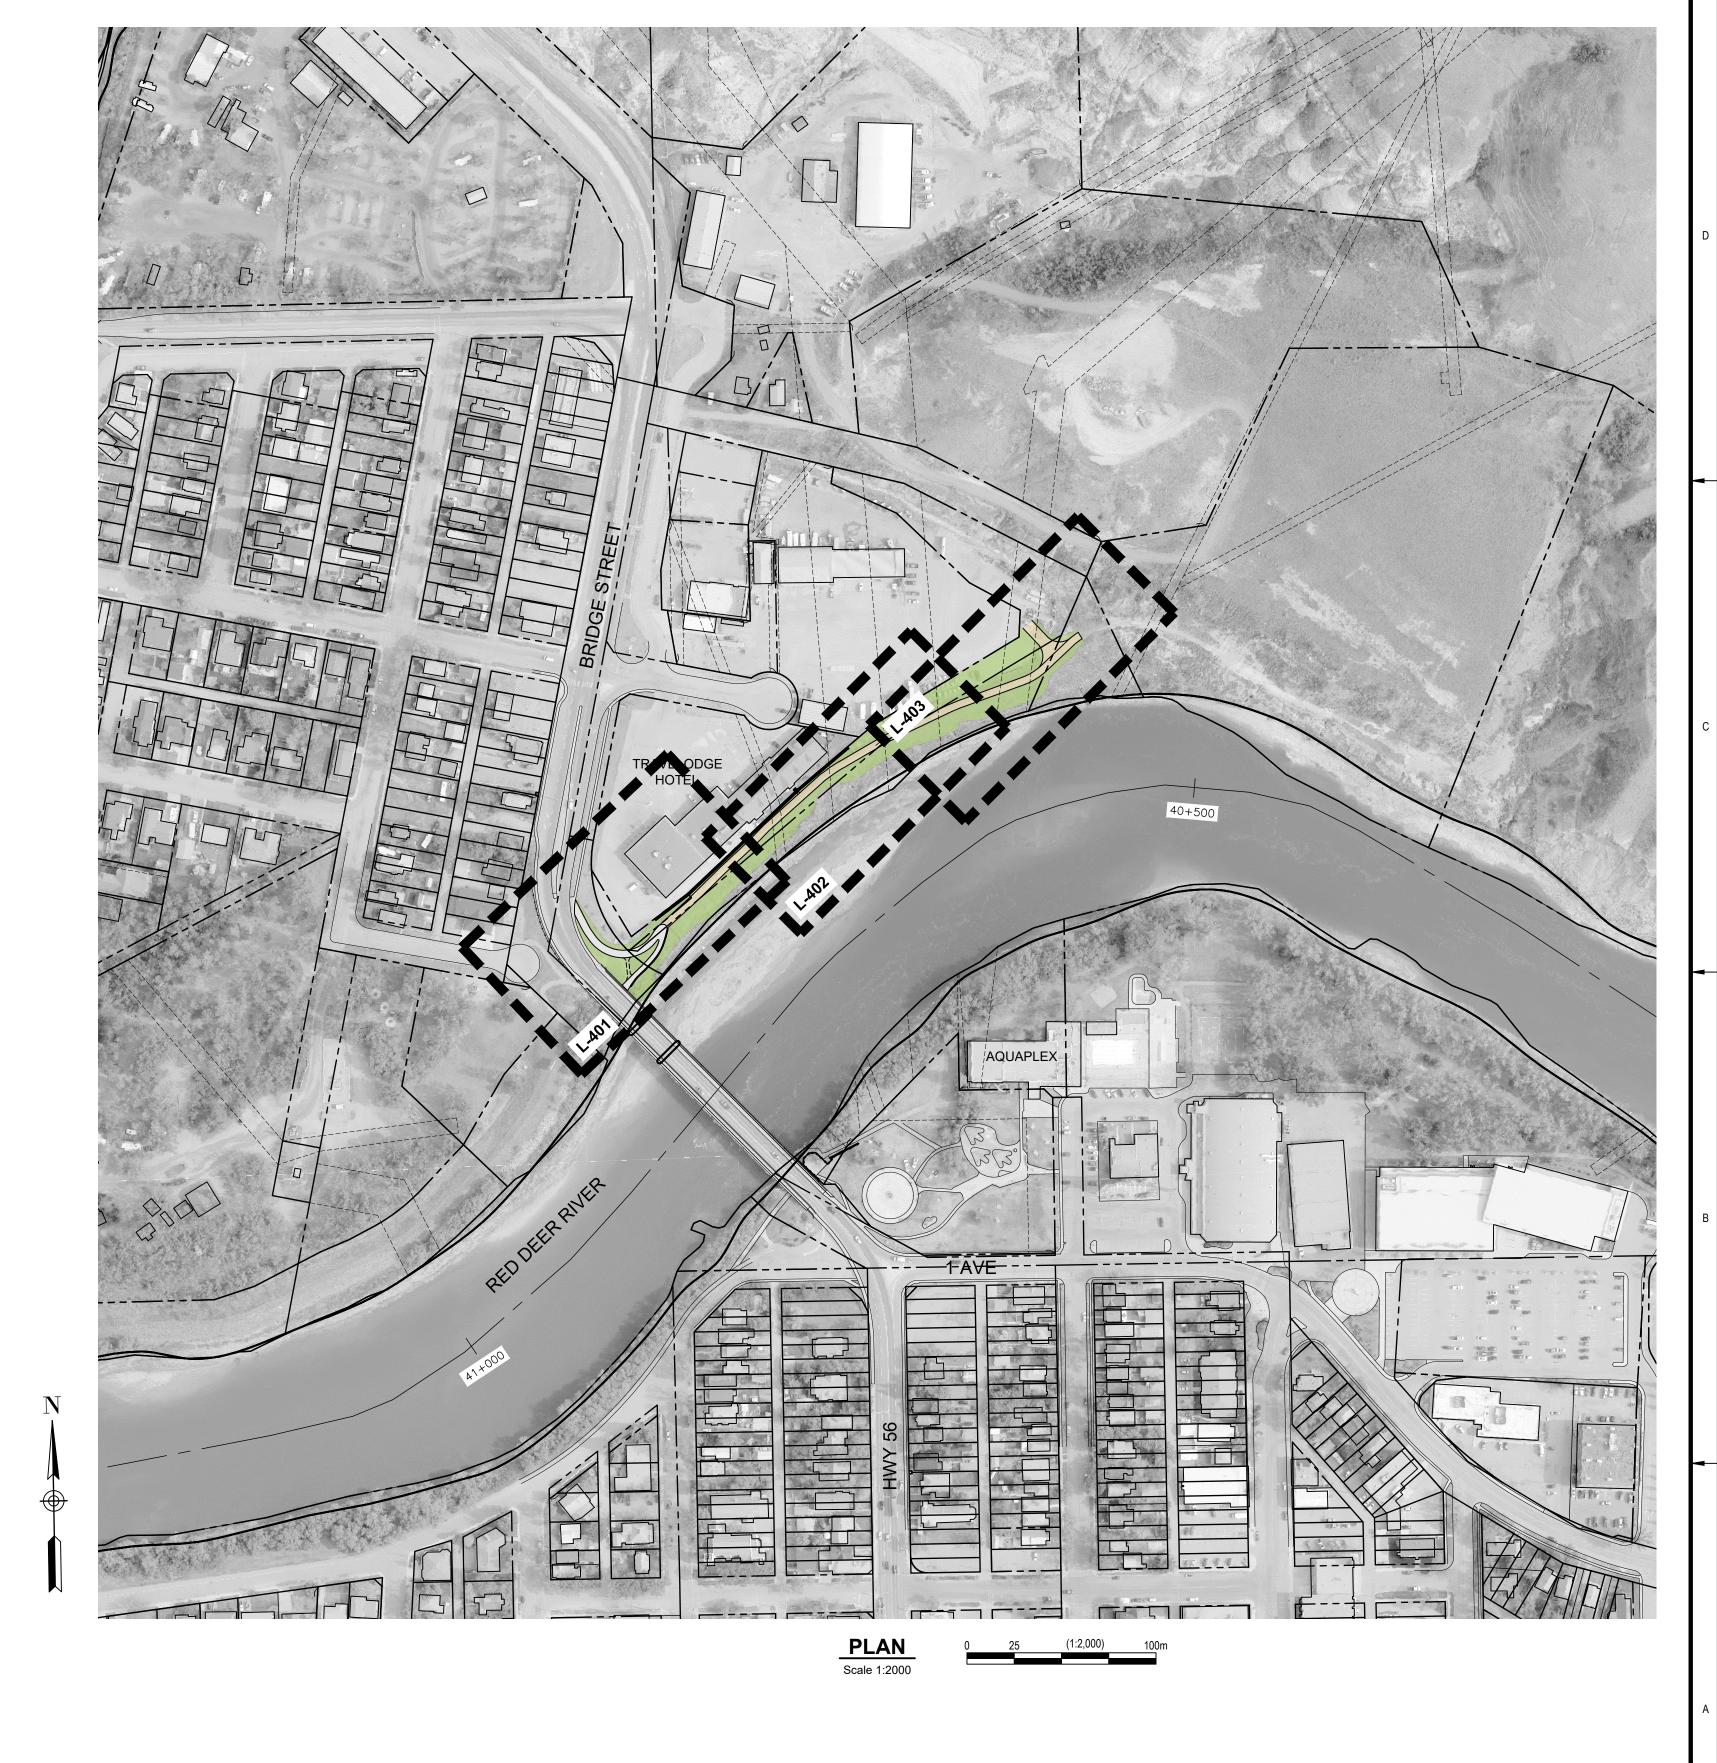





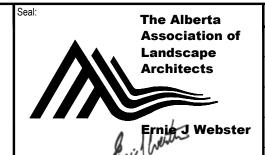

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	0	2022-10-28	EJW	MD	EJW	ISSUED FOR TENDER								PACKAGE C DIKE PROJECT
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TREE PLANTING SCHEDULE QTY. BOTANICAL NAME COMMON NAME SIZE CONDITION CONIFEROUS TREES PICEA GLAUCA WHITE SPRUCE 2500mm HT B&B WHITE SPRUCE B&B PICEA GLAUCA 2000mm HT WHITE SPRUCE PICEA GLAUCA 1500mm HT B&B PICEA PUNGENS **COLORADO SPRUCE** 2500mm HT B&B PICEA PUNGENS **COLORADO SPRUCE** 2000mm HT B&B 3 PICEA PUNGENS **COLORADO SPRUCE** 1500mm HT B&B DECIDUOUS TREES ACER NEGUNDO MANITOBA MAPLE 70mm CAL. B&B PATMORE GREEN ASH FRAXINUS PENNSYLVANICA 'PATMORE' B&B 70mm CAL.

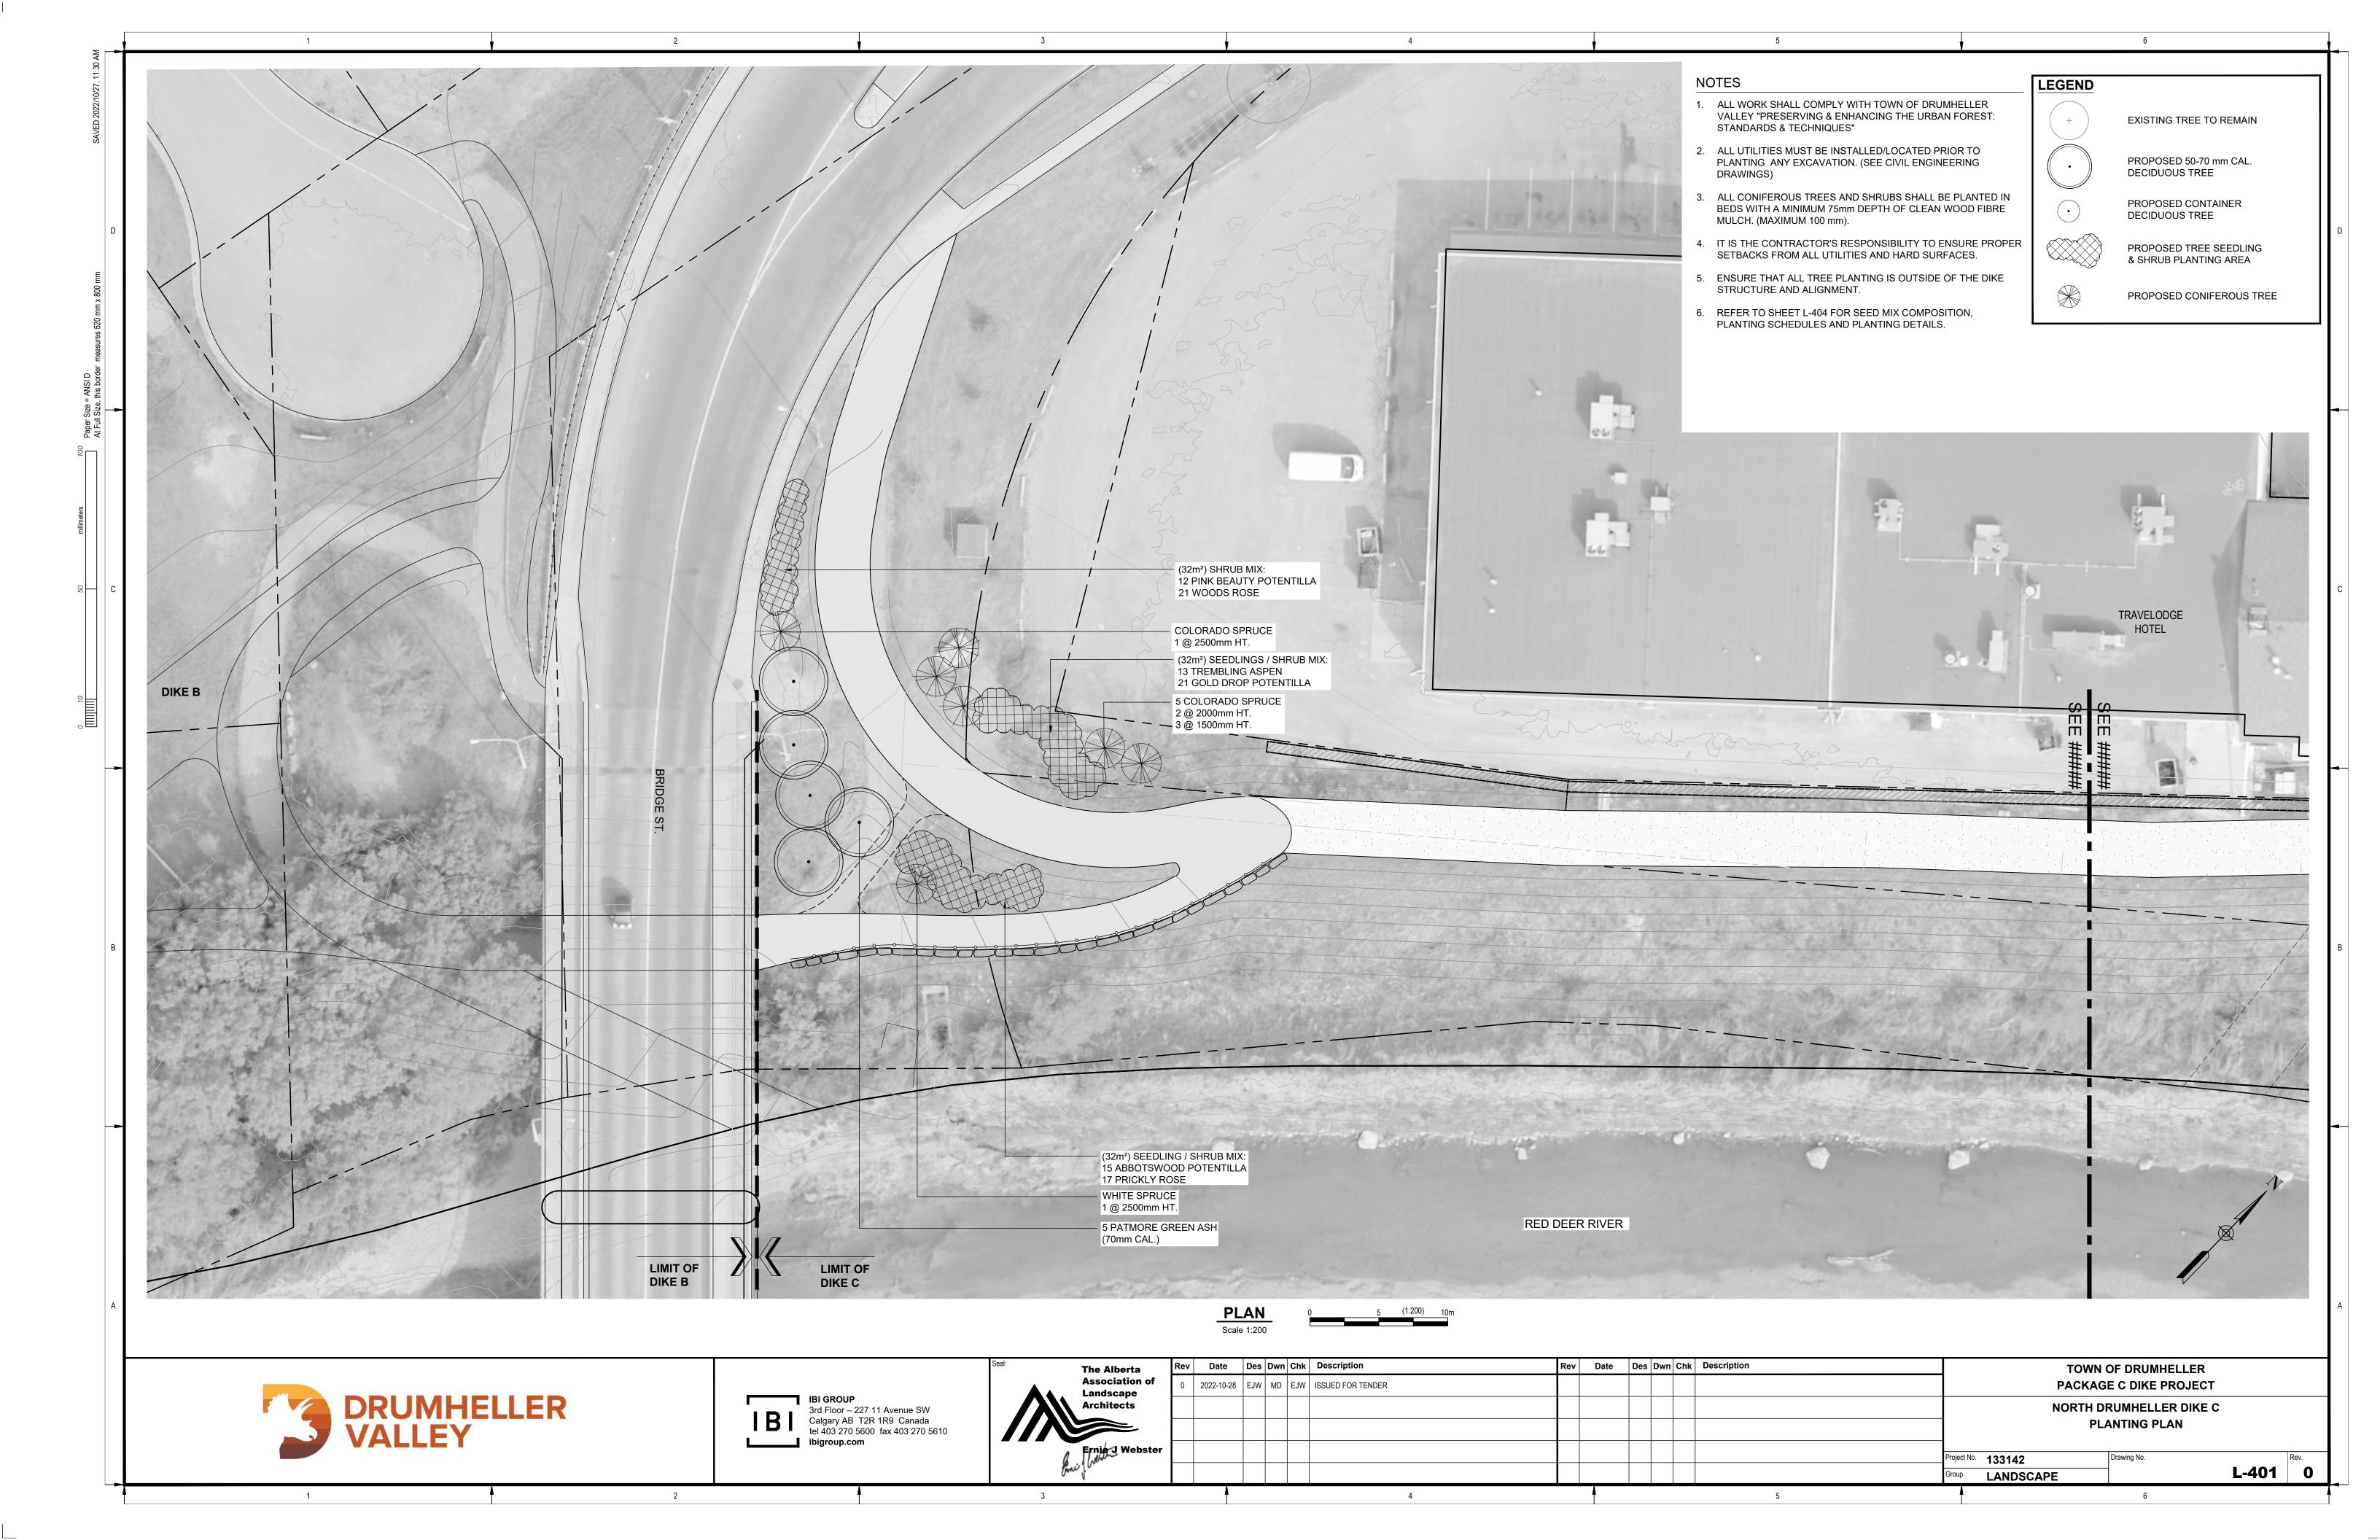TREMBLING ASPEN

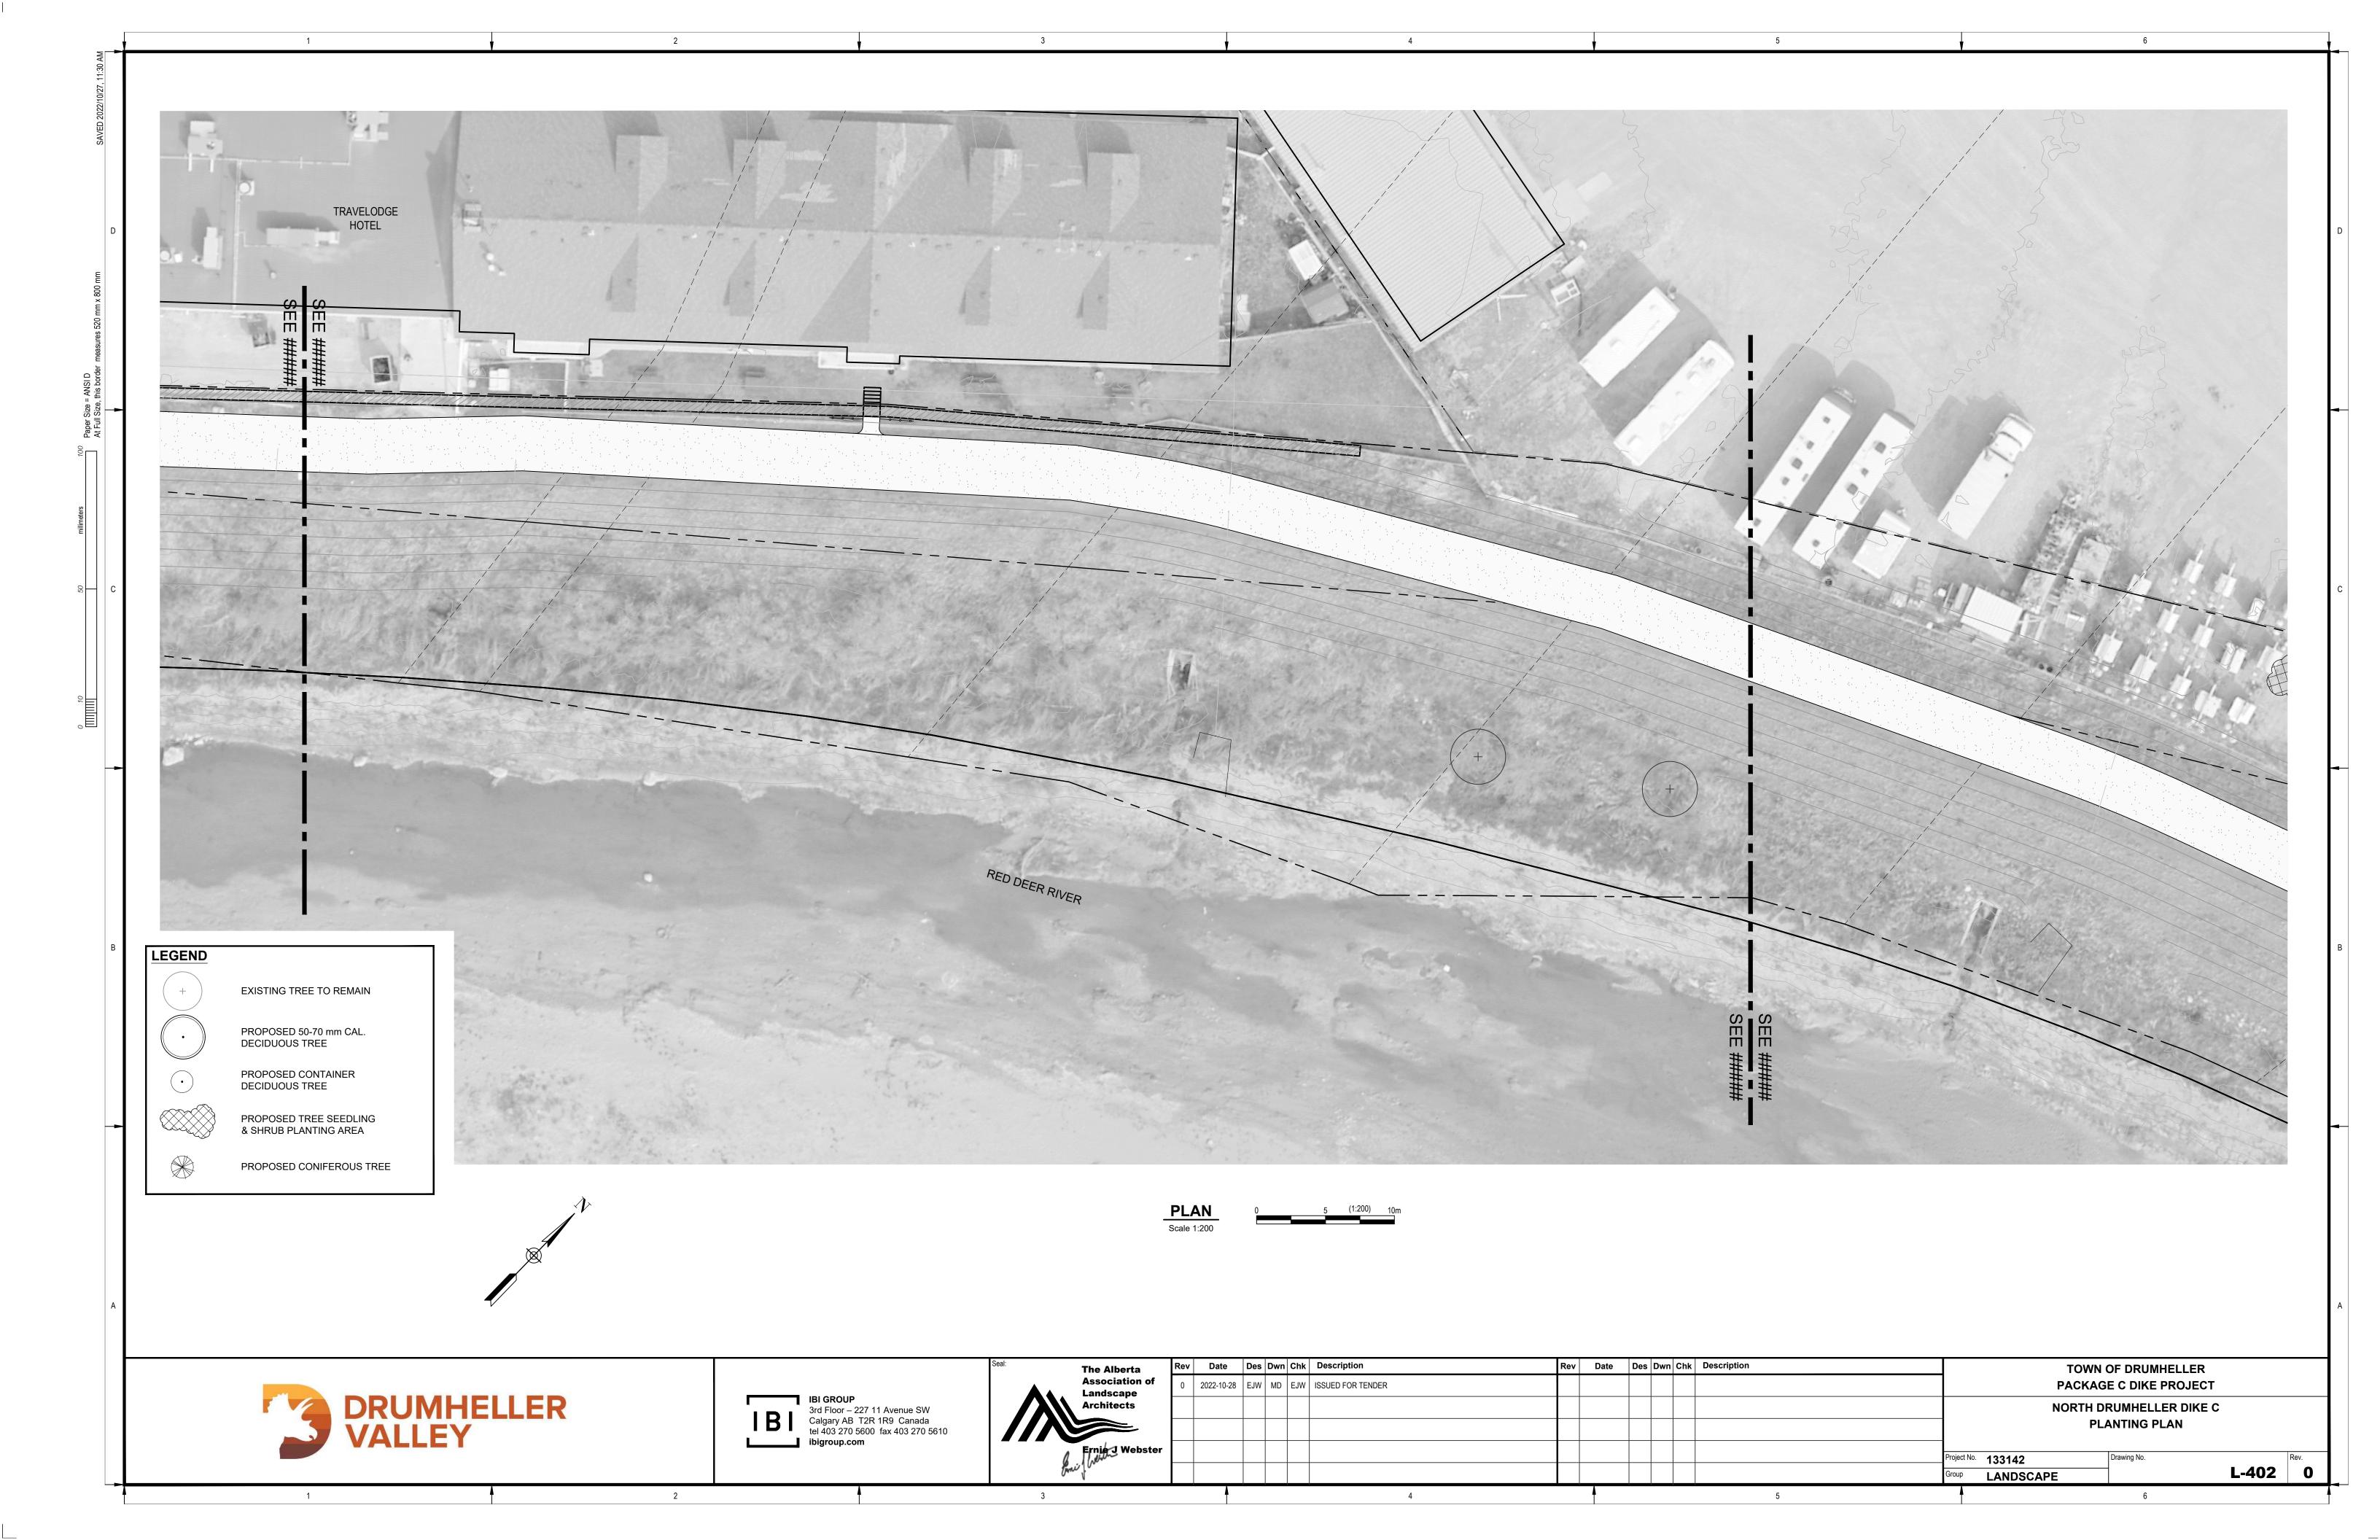SINGLE LEADER ONLY UNLESS

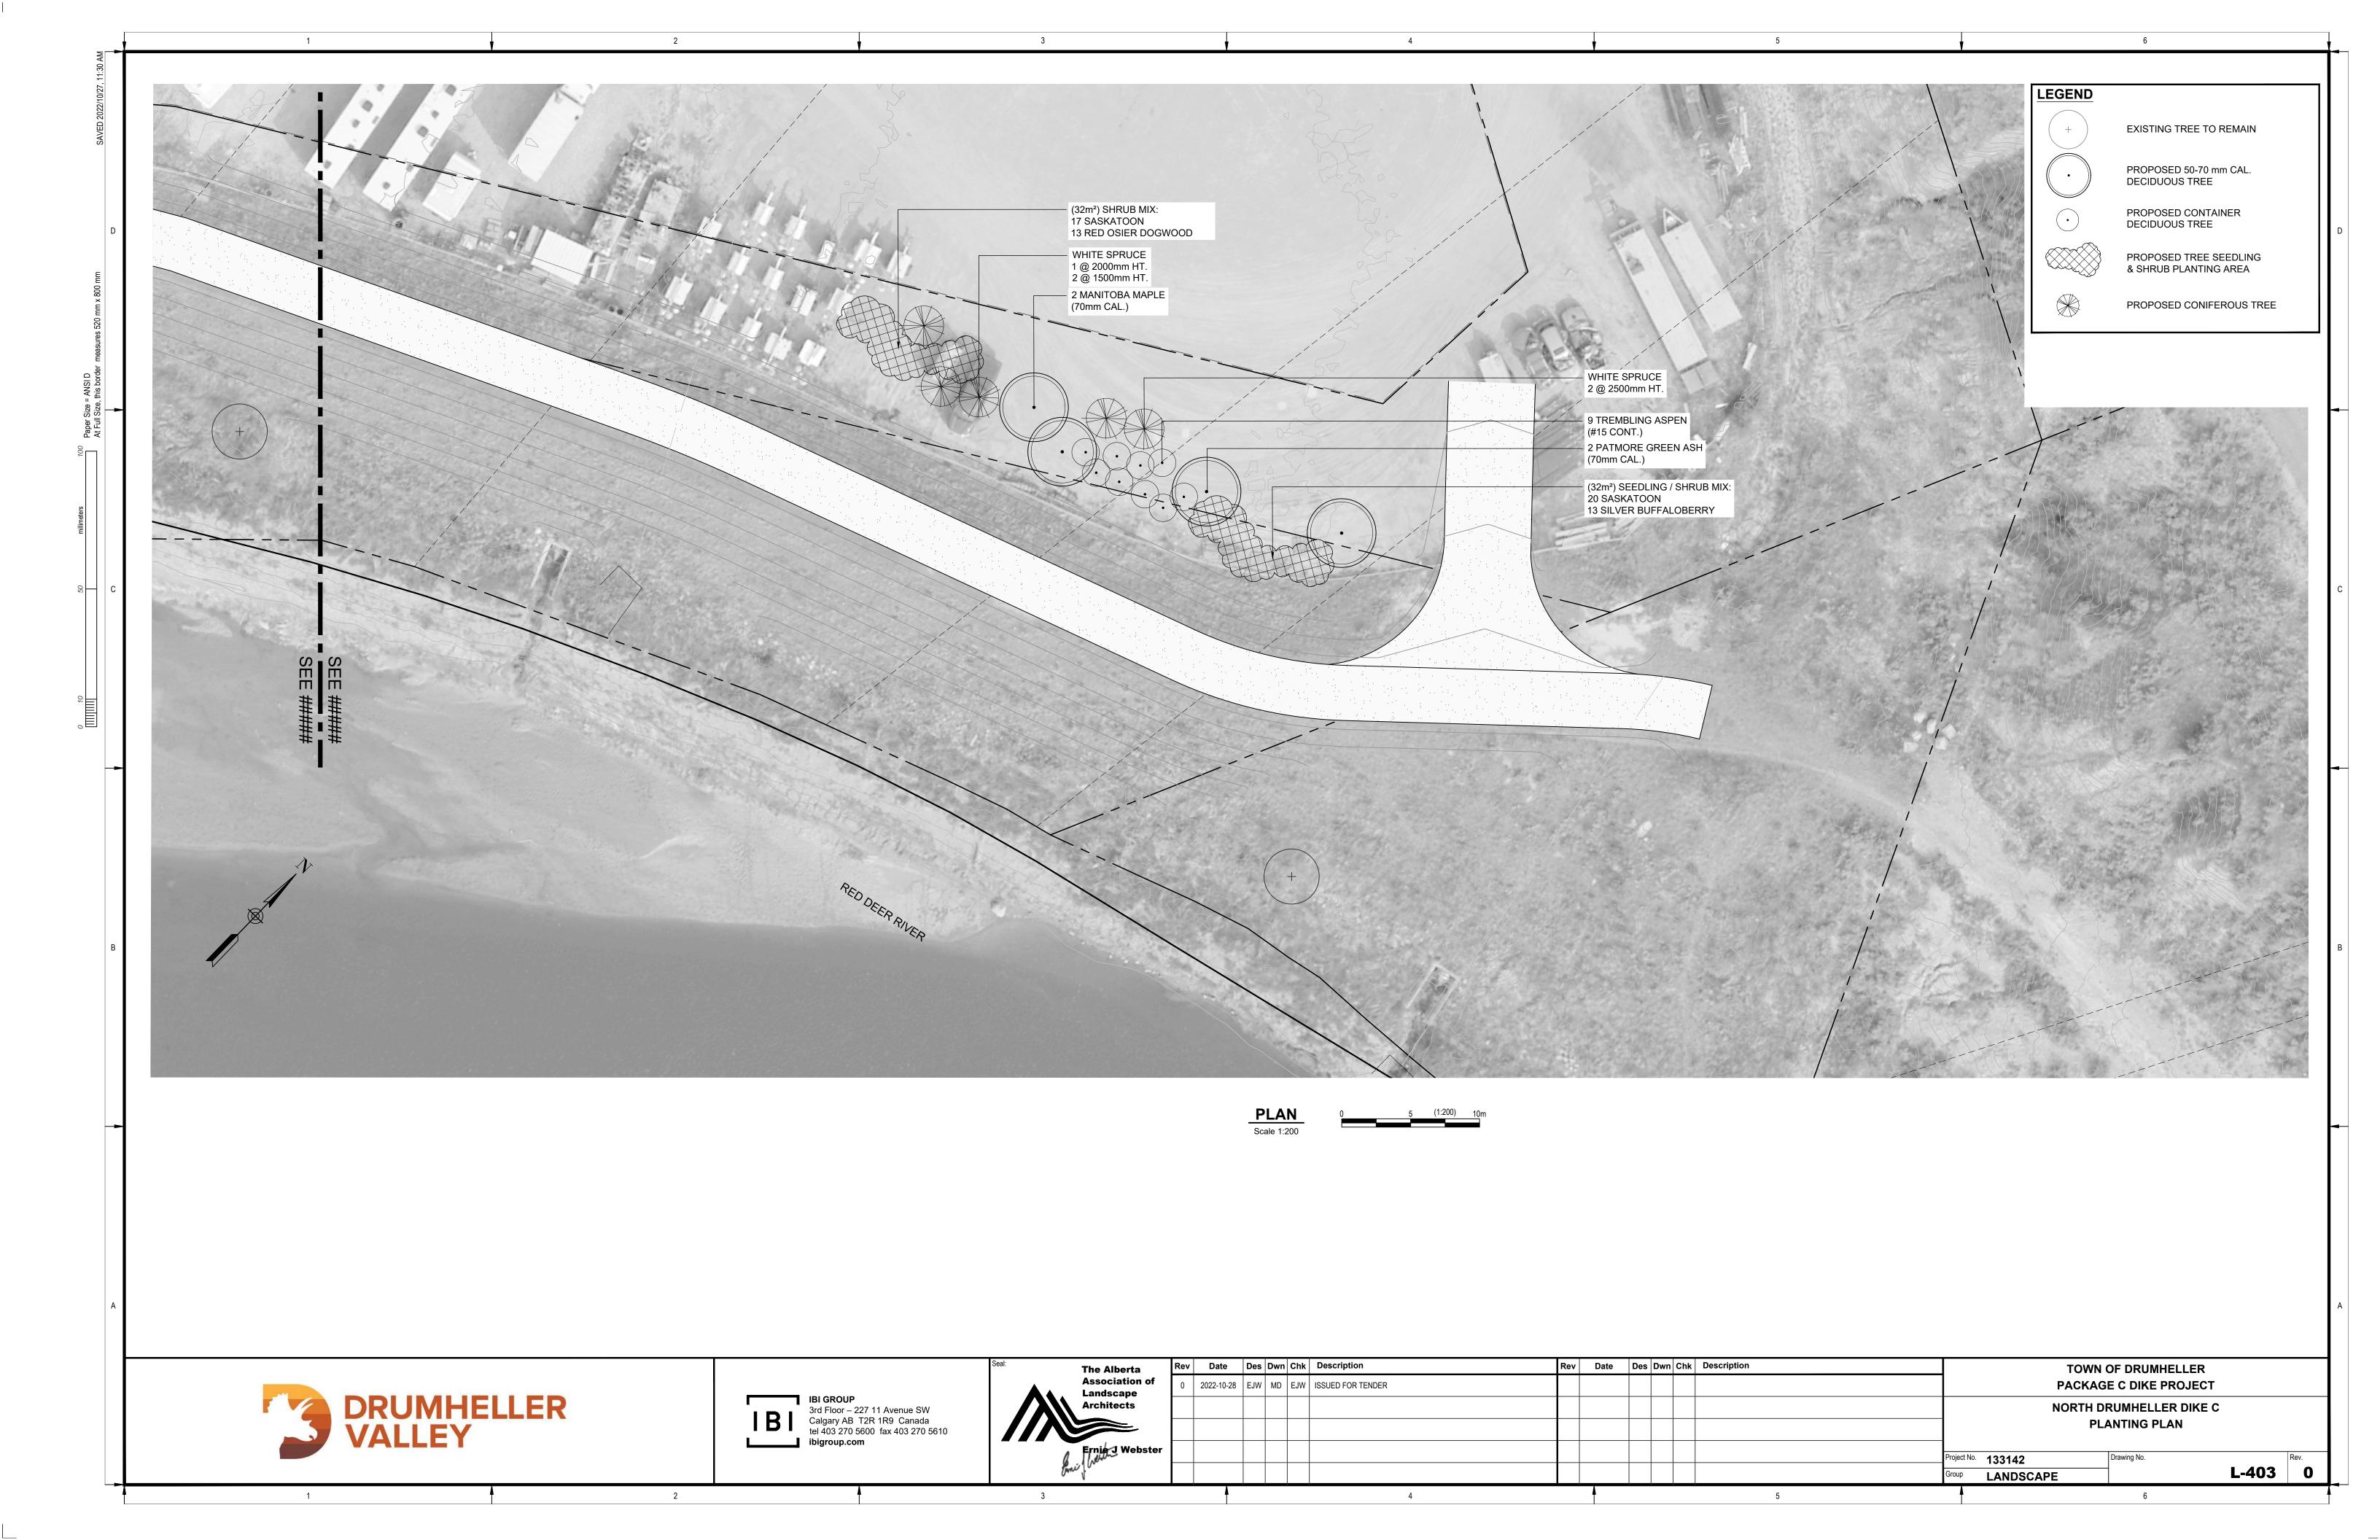CONTRACTOR TO ENSURE NO

DAMAGE OR PRUNING IS

MAINTENANCE

PREVAILING

MINIMUM 50 mm

MULTI STEM SPECIES SPECIFIED

PERFORMED TO LEADER DURING

INSTALLATION AND/OR FOLLOW-UP

- UNDISTURBED SOIL

CENTER AT 1:1 SLOPE MAXIMUM

SHRUB AND TREE SEEDLING SCHEDULE

9 POPULUS TREMULOIDES

QTY. E	BOTANICAL NAME		SIZE	CONDITION	SPACING						
DECIDUOL	US SHRUBS										
17 F	ROSA ACICULARIS	PRICKLY ROSE	600mm HT.	#2 CONT.	1.0-1.5m O.C.						
37 A	AMELANCHIER ALNIFOLIA	SASKATOON	600mm HT.	#2 CONT.	1.5-2.0m O.C.						
13 (CORNUS SERICEA	RED OSIER DOGWOOD	600mm HT.	#2 CONT.	2.5-3.0m O.C.						
13 F	POPULUS TREMULOIDES	TREMBLING ASPEN		SEEDLING	1.0m O.C.						
15 F	POTENTILLA FRUTICOSA 'ABBOTSWOOD'	ABBOTSWOOD POTENTILLA	400mm HT.	#2 CONT.	1.0-1.5m O.C.						
21 F	POTENTILLA FRUTICOSA 'GOLD DROP'	GOLD DROP POTENTILLA	400mm HT.	#2 CONT.	1.0-1.5m O.C.						
12 F	POTENTILLA FRUTICOSA 'PINK BEAUTY'	PINK BEAUTY POTENTILLA	400mm HT.	#2 CONT.	1.0-1.5m O.C.						
21 F	ROSA WOODSII	WOODS ROSE	400mm HT.	#2 CONT.	1.0-1.5m O.C.						
13 5	SHEPHERDIA ARGENTEA	SILVER BUFFALOBERRY	600mm HT.	#2 CONT.	2.5-3.0m O.C.						

TREE PLANTING STRATEGY

SHRUBS = 149 (78%)

TOTAL NUMBER OF FAIR, GOOD AND VERY GOOD TREES TO BE REMOVED = 15 TOTAL NUMBER OF NEW TREES AND SHRUBS REQUIRED TO BE PLANTED IN LIEU OF REMOVALS = 75

(AS PER THE TOWN OF DRUMHELLER "PRESERVING AND ENHANCING THE URBAN FOREST STANDARDS AND TECHNIQUES" WHERE A 5:1 RATIO OF PLANTING REPLACEMENT IS SPECIFIED, FOR EVERY 1 FAIR, GOOD, OR VERY GOOD TREE THAT IS REMOVED, 5 TREES/SHRUBS WILL BE PLANTED)

TOTAL REPLACEMENT PLANTS = 192

MED-LARGE TREES (50-70mm CAL.) = 21 (11%) SMALL CONTAINER GROWN TREES = 9 (5%) SEEDLING TREES = 13 (7%)

USE RUBBER STRAPS AT END OF GUY

12 mm $\binom{1}{2}$ ") BRAIDED NYLON STRAP OR

USE THREE (3) 50X50X2500 LNG. STUDDED -

HEAVYWEIGHT T-POSTS (7.5 POUND). ALL

FREE OF RUST AND PRIMED. TREE STAKE

UNDISTURBED SOIL WITH TWO ON SIDE OF

PREVAILING WINDS. STAKES ARE TO BE

REMOVED AFTER ONE GROWING SEASON

SCALE 1:40

SET MINIMUM OF 900 mm INTO

EXPOSED PORTIONS OF TREE STAKE TO BE

WIRES TO PROTECT THE TREE AT

POINT OF CONTACT

11 GAUGE WIRE

450 mm MINIMUM OR 2 (x)WIDTH OF ROOT BALL Ø

STANDARD TREE PLANTING

IF LESS THAN 300mm ADJACENT LOAM USED

PLANTING NOTES

- ALL PLANT MATERIAL SHALL BE INSTALLED IN ACCORDANCE WITH THE GUIDELINES AND SPECIFICATIONS OF DRUMHELLER VALLEY, THE DRUMHELLER VALLEY DOCUMENT, PRESERVING & ENHANCING THE URBAN FOREST: STANDARDS & TECHNIQUES AND AS PER PROJECT SPECIFIC PLANTING DETAILS LOCATED AT END OF DRAWING SET.
- PLANT MATERIAL LIST WAS PREPARED FOR ESTIMATING PURPOSES ONLY. CONTRACTOR SHALL MAKE THEIR OWN QUANTITY TAKE-OFFS USING DRAWINGS TO DETERMINE QUANTITIES, REPORTING PROMPTLY AND DISCREPANCIES WHICH MAY AFFECT BIDDING.
- THE OWNER'S REPRESENTATIVE WILL INSPECT PLANTS AT THE FOLLOWING STAGES; AT TIME OF DELIVERY PRIOR TO INSTALLATION. INSTALLED PLANTS BEFORE COMMENCEMENT OF MAINTENANCE PERIOD AND AT THE END OF MAINTENANCE PERIOD. NOTIFY OWNER'S REPRESENTATIVE 72 HOURS IN ADVANCE OF EACH REQUIRED INSPECTION. CONTRACTOR SHALL ENSURE REQUIRED PLANTS WILL BE AVAILABLE OR MEET SPECIFICATIONS BEFORE ARRANGING INSPECTION FOR SELECTION AND TAGGING OF PLANTS.
- ALL PLANT MATERIAL TO BE DISEASE FREE AND TRUE TO FORM, SPECIMEN GRADE SINGLE STEM STOCK -UNLESS NOTED OTHERWISE, PLANTS WILL BE REJECTED IF: SOIL BALLS HAVE BEEN CRACKED OR BROKEN BEFORE OR DURING PLANTING OR WHEN BURLAP ROPES REQUIRED IN CONNECTION WITH THEIR TRANSPLANTING HAVE BEEN REMOVED. DO NOT USE PLANTS DAMAGED DURING CONTACT WITH EQUIPMENT, OR PLANTS THAT ARE WILTED, WIND BURNED OR STRESSED. CONTRACTOR TO REPLACE DAMAGED OR REJECTED PLANTS AT NO ADDITIONAL COST TO OWNER.
- 5. STAKE OUT LOCATIONS OF TREES, SHRUBS AND PLANTING BEDS. LOCATIONS OF ALL PLANTS SHALL BE REVIEWED AND APPROVED BY OWNER'S REPRESENTATIVE ON SITE BEFORE PLANTING. PLANTS INSTALLED WITHOUT REVIEW AND APPROVAL MAY REQUIRE TRANSPLANTING OR RELOCATION AS DIRECTED BY OWNER'S REPRESENTATIVE AT NO ADDITIONAL COST.
- ENSURE ALL TREES AND SHRUBS ARE INSTALLED OUTSIDE OF DIKE EXTENTS REFER TO CIVIL DRAWINGS, TYP. 7. CONTRACTOR SHALL VERIFY THAT ALL MINIMUM CLEARANCES ARE PROVIDED BETWEEN PROPOSED TREES AND UNDERGROUND AND/OR OVERHEAD UTILITIES AS DEFINED BY THE LOCAL PARKS AND PLANNING DEPARTMENT. 8. PART OF PLANT MATERIAL INSTALLATION SHALL INCLUDE SUFFICIENT PROTECTION TO PREVENT BARK AND TREE DAMAGE DUE TO FORAGING ANIMALS AND ANCHORING SYSTEM TO PREVENT ROOT BREAKAGE DUE TO STRONG WINDS. LANDSCAPE ARCHITECT NOT RESPONSIBLE FOR ANY DAMAGES THAT INCUR DUE TO IMPROPER INSTALLATION.
- 9. DISTURBANCES TO ADJACENT AREAS SHALL BE REPAIRED TO THE SATISFACTION OF THE OWNER'S REPRESENTATIVE.
- 10. EROSION CONTROL MATTING REQUIRED ON ALL SLOPES GREATER THAN 3:1 THAT ARE INDICATED TO BE SEEDED.
- 11. SLOPES > 3:1 AND < 2:1
- 12. S150 STRAW FIBRE EROSION CONTROL MATTING WITH BIODEGRADABLE STAKES. REFER TO MANUFACTURERS SPECIFICATIONS FOR STAKING PATTERN.
- 13. SLOPES > 2:1

B&B

#15 CONT.

14. SC150 COCONUT AND STRAW FIBRE EROSION CONTROL MATTING WITH BIODEGRADABLE STAKES. REFER TO MANUFACTURERS SPECIFICATIONS FOR STAKING PATTERN.

WIDTH VARIES

NOTE: SOIL VOLUME EXTENDS BEYOND BED EDGE

IN SOFT LANDSCAPE CONDITIONS

SPACING AS PER PLANTING SHEETS

- 15. ALL DEVELOPMENT AND CONSTRUCTION ACTIVITIES WITHIN 6 METERS OF EXISTING VEGETATION MUST BE SUPERVISED BY AN ISA (INTERNATIONAL SOCIETY OF ARBORICULTURE) CERTIFIED ARBORIST.
- ALL PRUNING OF EXISTING VEGETATION MUST BE SUPERVISED BY AN ISA CERTIFIED ARBORIST

1000 min

Wet Tolerant Seed Mix 1 - Below 1:2-year high water mark - Application rate of 58 kg / ha.

BOTANICAL NAME	COMMON NAME	TARGET COVER	% OF SEED MIX (PLS)	Kg REQUIRE (PLS)
Deschampsia ceaspitosa	Tufted Hairgrass	25%	3%	1.97
Pascopyrum smithii / Agropyron smithii	Western Wheatgrass	20%	32%	18.60
Bromus carinatus	Mountain Brome	5%	10%	5.68
Elymus trachycaulus / Agropyron trachycaulum var.	Slender Wheatgrass	10%	11%	6.39
Elymus canadensis	Canada Wildrye	15%	23%	13.34
Spartina pectinata	Alkali Cordgrass	25%	21%	11.66

Cover crop for Wet Tolerant Seed Mix 1: Add a cover crop of Beckmannia Syzigachne (Slough Grass) at 5 kg / ha in areas of highwater erosion prone areas.

Upland Seed Mix 2A - Upland Areas - Application rate of 58 kg / ha.

BOTANICAL NAME	COMMON NAME	TARGET COVER	% OF SEED MIX (PLS)	Kg REQUIRED (PLS)
Elymus lanceolatus / Agropyron dasystachyum	Northern Wheatgrass	15%	16%	9.30
Pascopyrum smithii / Agropyron smithii	Western Wheatgrass	20%	30%	17.36
Elymus trachycaulus / Agropyron trachycaulum var.	Slender Wheatgrass	10%	10%	5.97
Bouteloua gracilis	Blue Grama	10%	2%	0.88
Elymus canadensis	Canada Wildrye	10%	14%	8.30
Nassella viridula / Stipa viridula	Green Needlegrass	25%	27%	15.82
Koeleria macrantha	Junegrass	10%	1%	0.58

Cover Crop for Upland Seed Mix 2: Add a cover crop of Lolium multiflorum (Annual Ryegrass) at 5 kg / ha for entirety of Upland Seed Mix areas.

Seed Mix 3 – Top of Berm

- Application rate of 50 kg / ha.

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BOTANICAL NAME	COMMON NAME	TARGET COVER	% OF SEED MIX (PLS)	Kg REQUIRED (PLS)
Elymus lanceolatus / Agropyron dasystachyum	Northern Wheatgrass	23%	46%	22.91
Pascopyrum smithii / Agropyron smithii	Western Wheatgrass	10%	23%	11.16
Bouteloua gracilis	Blue Grama	20%	6%	2.83
Hesperostipa comata / Stipa comata	Needle and Thread	2%	4%	2.13
Poa sandbergii	Sandberg Bluegrass	15%	6%	3.07
Nassella viridula / Stipa viridula	Green Needlegrass	5%	9%	4.24
Koeleria macrantha	Junegrass	23%	4%	2.13
Dalea purpurea	Purple Prairie Clover	2%	2%	1.02

Cover crop for Top of Berm Seed Mix 3: Add a cover crop of Lolium multiflorum (Annual Ryegrass) at 5 kg / ha for entirety of Top of Berm Seed Mix areas.

3 X 1800 mm (6') HT. PAINTED STEEL

- 2 PLY REINFORCED RUBBER GARDEN HOSE

OF SOIL MIX. DO NOT MOUND UP SOIL MIX

COMPACTED SUBGRADE

REST ROOTBALL ON COMPACTED

SUBGRADE OR COMPACTED FILL

TOP OF ROOT BALL TO BE 50 mm ABOVE TOP

- BACK FILL EXCAVATION WITH RAW LOAM

75MM DEPTH SHREDDED BARK MULCH,

MULCH PULLED BACK 50mm FROM TREE

U &/OR T BAR SUNK 300 mm (12")

BELOW COMPACTED SUBGRADE

AROUND TOP OF ROOT BALL

FLARE, TYPICAL

Site Characteristics Broadcast Habitat Type Dry Mixedgrass Natural Subregion Incorporation Method | ATV Harrow or hand rake Depth of Incorporation | 5cm to 10cm

Site Characteristics Seeding Method Broadcast Habitat Type Deciduous forest Natural Subregion Dry Mixedgrass Incorporation Method | ATV Harrow or hand rake

Depth of Incorporation | 5cm to 10cm


Site Characteristics								
Seeding Method	Broadcast or manual							
Habitat Type	Deciduous forest							
Natural Subregion	Dry Mixedgrass							
Incorporation Method	ATV Harrow or hand rake							

Depth of Incorporation | 5cm to 10cm

SEEDING NOTES

- ENSURE SEED MIXTURE IS FREE OF ANY WEED SEEDS LISTED AS "PROHIBITED NOXIOUS" OR "NOXIOUS" UNDER THE WEED CONTROL ACT AND SEEDS OF OTHER SPECIES THAT WILL INTERFERE WITH THE GROWTH OF THE SPECIFIED SEED MIXTURE.
- 2. SOW AT THE RATE INDICATED WITH SEED MIXES, DURING CALM WEATHER AND WHEN SOIL MOISTURE CONTENT IS ADEQUATE FOR GERMINATION. FOR SLOPES 2:1 OR FLATTER AREAS TO BE SEEDED THAT ARE EASILY
- ACCESSIBLE APPLY SEED USING A MECHANICAL DRY SPREAD "BRILLION" SEEDER THAT PLACES SEED AT SPECIFIED DEPTH AND RATE AND ROLLS IN A SINGLE OPERATION. 4. FOR STEEPER THAN 2:1 SLOPES OR SLOPES THAT ARE NOT EASILY
- ACCESSIBLE USE MANUALLY OPERATED BROADCAST SEEDER.
- SOW SEED IN TWO DIRECTIONS, 50% OF SEED IN ONE DIRECTION AND REMAINING 50% OF SEED AT RIGHT ANGLES TO FIRST SEEDING PATTERN, USING SAME METHOD OF SEEDING.
- 6. COVER BROADCASTED SEED BY HAND RAKING AND ATV HARROWING-IN.
- 7. OPTIMAL SEEDING PERIODS FOR NATIVE GRASSES:
- 7.1. MID TO LATE MAY, EARLY JUNE NO LATER THAN JUNE 15TH.
- 7.2. LATE SEPTEMBER AFTER FIRST HARD FROST WHEN PLANTS GO DORMANT. DO NOT SEED NEAR END OF SEASON UNTIL THE RISK OF SEED GERMINATION IS LOW. SEED THAT GERMINATES AND DOES NOT FULLY ESTABLISH PRIOR TO END OF GROWING SEASON WILL LIKELY NOT OVERWINTER.
- 8. WATER THE SEEDED AREAS AFTER SEEDING TO ACHIEVE GERMINATION AND A UNIFORM STAND OF GRASS. THE OWNER WILL DETERMINE THE WATERING SCHEDULE AND WILL PROVIDE THE CONTRACTOR WITH AT LEAST 24 HOURS ADVANCE NOTICE TO COMMENCE WATERING SEEDED AREAS.
- 9. APPLY WATER UNIFORMLY TO SEEDED AREAS WITHOUT CAUSING
- DISPLACEMENT OR EROSION OF THE MATERIALS AND TOPSOIL.
- 10. MINIMIZE TRAVEL ON SEEDED SURFACES. 11. USE WATERING EQUIPMENT AND TECHNIQUES AUTHORIZED BY THE OWNER.

SEED MIX SCHEDULES AND SEEDING NOTES PROVIDED FOR REFERENCE ONLY, FOR AREAS REQUIRING REPAIR AND REHABILITATION AS PART OF THIS SCOPE OF WORK. REFER TO SPECIFICATIONS IN CONTRACT 1 - BERM CONSTRUCTION + SODDING/SEEDING.

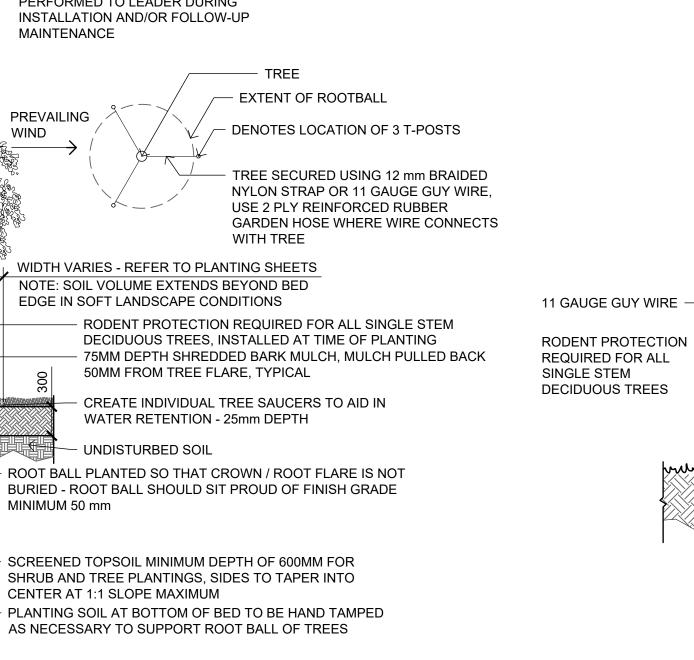


ALONG WET SIDE OF DIKE OR IN NATURALIZED AREAS. B MIXED PLANTING BED WITH MULCH SCALE 1:40 L-404

NOTE: MULCH IS NOT TO BE USED





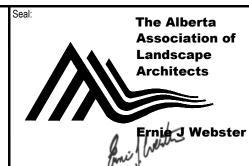

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